



**TOWN OF NEWBURGH  
PLANNING BOARD  
TECHNICAL REVIEW COMMENTS**

**PROJECT NAME:** DARRIGO SOLAR  
**PROJECT NO.:** 19-24  
**PROJECT LOCATION:** SECTION 86, BLOCK 1, LOT 96  
**REVIEW DATE:** 26 JANUARY 2024  
**MEETING DATE:** 1 FEBRUARY 2024  
**PROJECT REPRESENTATIVE:** ARDEN CONSULTING

1. The Project proposes a revised landscape plan and a phased construction of the project. Two phases are proposed a 4 MW and a 1 MW phase . The plan should depict each phase clearly.
2. A cost estimate is provided. It appears the estimate is for the entire project, and not broken into phases.
3. Construction of the Patton Road drainage improvements and the maintenance of the swale should be noted to be complete in the initial construction time period .
4. Confirm the fencing on the southeast portion of the site.
5. Dominic Cordisco comments on the need for a referral to county plan should be received.

Respectfully submitted,

**MHE Engineering, D.P.C.**

A handwritten signature in blue ink that reads 'Patrick J. Hines'.

Patrick J. Hines  
Principal  
PJH/dns

**NEW YORK OFFICE**


33 Airport Center Drive, Suite 202, New Windsor, NY 12553  
845-567-3100 | F: 845-567-3232 | mheny@mhepc.com

**PENNSYLVANIA OFFICE**

111 Wheatfield Drive, Suite 1, Milford, PA 18337  
570-296-2765 | F: 570-296-2767 | mhempa@mhepc.com

22 January 2024

Town of Newburgh Planning Board  
John Ewasutyn, Chairperson & Planning Board Members  
21 Hudson Valley Professional Plaza  
Newburgh, NY 12550

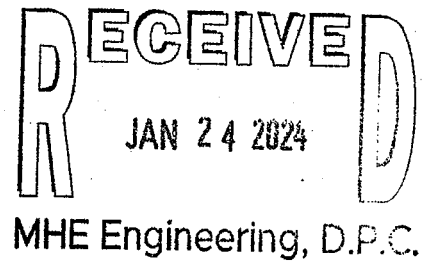

Jeffrey Lease, Representative  
Darrigo Solar Farm  
5020 Route 9W  
Newburgh, NY 12550

Re: Darrigo Solar Farm, 84 Lakeside Road, Newburgh, New York  
Town Planning Board Number 2019-2024

The former Landscape Architect for this project retired and so the revised landscape plans have been redrawn by a new office, ULS of Saratoga Springs, New York.

Because of New York State power regulations, the 5 MW project is in the NYSERDA database and Central Hudson que as a 4MW and two 0.50 MW projects. We learned after preliminary approval that Central Hudson could not take all the power to the substation at one time.

Since then the substation connector has been improved and has just become available, but approval for interconnection by Central Hudson will take up to three months. Once approved the two 0.5 MW projects will be built at the same time.

I request that the project be built in two parts, Phase I being the 4 MW project and Phase II being the two 0.5 MW projects. The completion of Phase II will occur no longer than 6 months after Phase I. All the site improvements will be completed with Phase I.

Respectfully,

A handwritten signature in black ink, appearing to read "Jeffrey Lease". The signature is fluid and cursive.

Jeffrey Lease  
845.542.0345

2/8/2022

RECEIVED  
JAN 24 2024  
MHE Engineering, D.P.C.

Private Owner  
Jeffrey Lease  
597 GRAND AVENUE  
NEWBURGH, NY 12550

**RE: ACKNOWLEDGMENT of NOTICE OF INTENT for  
Coverage Under SPDES General Permit for  
Storm Water Discharges from CONSTRUCTION  
ACTIVITY – General Permit No. GP-0-20-001**

Dear Prospective Permittee:

This is to acknowledge that the New York State Department of Environmental Conservation (Department) has received a complete Notice of Intent (NOI) for coverage under General Permit No. GP-0-20-001 for the construction activities located at:

**Solar Farm Site Plan for Darrigo Farm  
84 Lakeside Avenue  
Newburgh, NY 12550**

**County: ORANGE**

Pursuant to Environmental Conservation Law (ECL) Article 17, Titles 7 and 8, and ECL Article 70, discharges in accordance with GP-0-20-001 from the above construction site will be authorized **5** business days from **2/7/2022**, which is the date we received your final NOI, unless notified differently by the Department.

The permit identification number for this site is: **NYR11J306**. Be sure to include this permit identification number on any forms or correspondence you send us. When coverage under the permit is no longer needed, you must submit a Notice of Termination to the Department.

This authorization is conditioned upon the following:

1. The information submitted in the NOI received by the Department on **2/7/2022** is accurate and complete.
2. You have developed a Stormwater Pollution Prevention Plan (SWPPP) that complies with GP-0-20-001 which must be implemented as the first element of construction at the above-noted construction site.
3. Activities related to the above construction site comply with all other requirements of GP-0-20-001.



**4. Payment of the annual \$110 regulatory fee, which is billed separately by the Department in the late fall. The regulatory fee covers a period of one calendar year. In addition, since September 1, 2004, construction stormwater permittees have been assessed an initial authorization fee which is now \$110 per acre of land disturbed and \$675 per acre of future impervious area. The initial authorization fee covers the duration of the authorized disturbance.**

5. Your SWPPP has been reviewed by the regulated, traditional land use control MS4 where your project is located and has been determined to be in substantive conformance with the requirements in the SPDES General Permit for Stormwater Discharges from MS4s.

**6. Before disturbing greater than 5 acres of soil at any one time, you have obtained written authorization from the regulated, traditional land use control MS4 that has jurisdiction over the project.**

7. When applicable, project review pursuant to the State Environmental Quality Review Act (SEQRA) has been satisfied.


8. You have obtained all necessary Department permits subject to the Uniform Procedures Act (UPA). You should check with your Regional Permit Administrator for further information.

**\*Note: Construction activities cannot commence until project review pursuant to SEQRA has been satisfied, when SEQRA is applicable; and, where required, all necessary Department permits subject to the UPA have been obtained.**

Please be advised that the Department may request a copy of your SWPPP for review.

Should you have any questions regarding any aspect of the requirements specified in GP-0-20-001, please contact Dave Gasper at (518) 402-8114.

Sincerely,

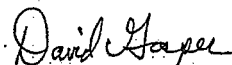

David Gasper  
Environmental Engineer

cc: RWE - 3  
SWPPP Preparer  
ARDEN CONSULTING ENGINEERS  
MORGANTE MICHAEL  
PO BOX 340  
MONROE, NY 10949

Date: January 23, 2024

To: Karen Arent  
Karen Arent Landscape Architect  
12 Old Minisink Trail Goshen, New York 10924  
Phone: 845-294-9958 Email: KALA@hve.rr.com

From: Erin Maciel, RLA Principal- Urban Landscape Studio Landscape Architecture PLLC

Subject: Darrigo Solar Farm Landscape Plan Comment Response Memo  
Comments Received by Email (Town Project Number 2019-14)

**RECEIVED**  
JAN 24 2024  
MHE Engineering, D.P.C.

Dear Ms. Arent,

The following is a list of outstanding comments received from your office on January 6, 2022 and our corresponding responses (in red) that have been addressed in the latest plan set submittal (January 23, 2024).

4. Screen planting along the southern and easter property lines include some larger trees at the time of planting. However, the planting should include some evergreens such as Red Cedar Juniper (which will look very natural as it is commonly found along the highway). Also include more plants. This area should look like a forest. The Oak trees are shown 100' wide. This may never happen and if it grows that large, it will take decades. Please mimic nature but at an accelerated pace. Maybe show 9 Oaks. Show a forest in this area. Additional tree and shrub plantings have been included for the restoration area along I84. The plant list for this area has been updated to include more evergreen trees (Eastern Red Cedar and White Pine).
5. No fence details were included. Please include a detail for the proposed fencing at the lakeside road entrance. Fence and gate details have been added on Sheet L-502.
6. Please forward the enlarged planting plan so we can make sure this comment was addressed. Enlarged planting plans have been included in the updated plan set.
7. -----
8. This comment was not addressed. Please show many more plants, several of which are larger in size at time of planting, to provide screening of the access drive that runs between the two residential properties off Lakeside Dr. Consider a thickly planted hedge of Bottlebrush Buckeye, Aesculus parviflora. It grows in both sun and shade and grows 12'+ in height. The planting plan has been updated accordingly.
9. Please forward the enlarged planting plan so we can make sure this comment was addressed. Taxus x media has been removed from the planting plan and replaced with Ilex glabra. Enlarged planting plan has also been included in the updated plan set.
10. Red cedars are pioneer species that require full sun and Gray Dogwood is not deer resistant. Instead propose layers of shade and deer-tolerant species such as Hamamelis virginiana (Witchhazel) and Aesculus parviflora, Bottlebrush Buckeye. Eastern Red Cedar has been replaced with thuja occidentalis 'Techny' due to its tolerance of partial shade. Bridal wreath spirea, winterberry and red-twig dogwood has been included as understory plantings.

**URBAN LANDSCAPE STUDIO**  
Landscape Architecture PLLC

153 Van Dam Street | Saratoga Springs, New York | Phone: 347.541.0281 | Email: erin.maciel@uls-ny.com

Additional items that must be addressed:

1. Another concern that we discussed is the sloped area between the solar arrays. Please take off the word top. Trees should never be topped! Please remove the Red Maples or show them only at the bottom of the slope as they will get too tall. Consider replacing with 100 Bottlebrush Buckeye, *Aesculus parviflora*. Note removed. Planting plan amended.
2. Please remove note 23 on the planting notes. regarding tree topping. NO trees should be topped. Note removed.
3. Amend note 20 to read that the guarantee is for a two year period. Note amended.
4. Amend note 21 to include that the plants will be inspected each growing season and those deemed 25% or more dead or otherwise unfit are to be replaced every growing season as well. Note amended.

We look forward to scheduling a virtual plan review with you to address any further comments to the landscape plans. Please let us know a date and time that is convenient for you.

Kindly,

*Erin Maciel, RLA*

Erin Maciel, RLA, Principal  
URBAN LANDSCAPE STUDIO  
Landscape Architecture PLLC

Attachments:

Landscape Comments (January 27, 2021)  
Landscape Comments (January 6, 2022)

# KALA

Karen Arent Landscape Architect

---

## Memorandum

**To:** Chairman John Ewasutyn and the Town of Newburgh Planning Board

**From:** Karen Arent, Landscape Architect

**Date:** January 27, 2021

**Subject:** Darrigo Solar Farm Landscape Plan Dated November 5, 2020

**Town Project Number:** 2019-14

**Consultant:** Jeff Lease

**Cc:** Pat Hines, Dominick Cordisco, Gerald Canfield, Scott Manley, Jeff Lease

## COMMENTS:

---

We reviewed the latest proposed landscape plan for Darrigo Solar Farm and found that significant changes were made to the plans that provide better screening than previously issued plans. The surrounding buffer area of existing vegetation and wooded areas has been expanded. Formerly the buffer was 50' wide in many areas and at the northwest part of the property it was expanded to 150'. Along the northern property line adjacent to residences along Meadow Hill Road the buffer was increased to 120' and more area along the proposed driveway was preserved. Along the eastern property line, the buffer was increased to 100'. This provides screening of the solar arrays as most areas inside the buffer are densely wooded.

The following comments are listed for discussion with the planning board:

1. Please include notes on the drawing that existing topsoil will remain and will not be trucked off site.
2. The proposed screening planting technique along the southern and eastern property lines may be beneficial in the future as smaller plants need less care after planting and have less risk of shock than larger plants. However, neighbors may voice screening concerns due to the small size of plants. Perhaps a few plants should be specified that are larger in size?

Comments for Darrigo Solar Farm  
Dated January 27, 2021

3. Please consider planting native shrubs that form thick masses such as *Cornus amomum*, Silky Dogwood, to block grade level views of the solar arrays in various locations.
4. Deciduous screen planting is proposed along the property line adjacent to Interstate 84 as these plantings will blend in better with existing plants in the area. However, screening will be lacking come winter when the leaves have fallen so this should be discussed with the planning board. The size of the trees for proposed screening should also be discussed as all plants are small in size and will not be visible for quite some time.
5. Please include a detail for the proposed fencing at the Lakeside road entrance. This fence will be highly visible from the road and it should be aesthetically pleasing.
6. *Erianthus ravennae* has been proposed at the Lakeside Road entrance. It is a non-native plant which spreads from ornamental plantings along roadsides and other disturbed edge habitats and has been reported as invasive in Western, Midwestern, and Southern states, as near as Ohio and Maryland. Please consider using a native grass, or other grass without reported invasive tendencies.
7. Additional screening has not been provided for residences that border the site and are on Lakeside road per previous comment 6.
8. Utility poles, remain proposed off Meadow Hill Road, across from Monarch Drive, and will have a negative visual impact on the neighborhood. Please consider screening with more low growing trees such as Shadblows. Also consider planting trees in larger sizes to provide more immediate screening to mitigate negative visual impacts of the proposed entrance drive and telephone poles. A gate is also recommended to keep people from hanging out in cars next to the neighboring residential properties. Please show an aesthetically pleasing gate and locate it 20-30' from Meadow Hill Road to allow a car or truck to pull in while opening the gate to get in.
9. *Taxus x media* 'Nigra' has been proposed at the Meadow Hill Road entrance. *Taxus* is very susceptible to deer browsing. It is nice to have well-spaced evergreens but it would take decades for the *Taxus* to grow to the approximate mature plant size illustrated on the plan. For these reasons we suggest replacing them with a different evergreen. Also, when proposing mature spacing for shrubs, low growing plants or groundcovers should be specified to fill in and help prevent



Comments for Darrigo Solar Farm  
Dated January 27, 2021

weeds from taking over while shrubs grow into their mature size. We recommend proposing some at the Meadow Hill Road entrance.

10. Additional screening has not been provided for the residence off Patton Road on the west side of the property or the residence off Meadow Hill Road at the intersection of Meadow Hill Road and Patton Drive per previous comment 7.
11. Please describe on the plan what is meant by “6-8” wattle of whips” as a planting size.
12. Scotch Pines are not native and may not grow well in this area. We suggest the use of a native evergreen tree better suited to the environment.
13. *Picea glauca* grow so slowly that they will not reach a size suitable for screening for decades. We recommend fast growing native shrubs that form dense thickets. Also please consider specifying Red Cedar Juniper or another native evergreen tree for winter interest.

**From:** KarenArentDesign@Frontier.com   
**Subject:** RE: Darrigo solar farm  
**Date:** January 6, 2022 at 12:49 PM  
**To:** jefflease@johnleaserealtors.com

---

Hello Jeff:

Here is a list of my concerns:

Most comments prepared Jan 27 were not addressed. Here's a brief synopsis of the comments and what we discussed yesterday along with some of the other comments that were not addressed. Comments correspond to comments dated Jan 27, 2021. I attach this comment letter for your reference.

1. Addressed.
2. Addressed.
3. Addressed.
4. Screen planting along the southern and eastern property lines include some larger trees at the time of planting. However, the planting should include some evergreens such as Red Cedar Juniper (which will look very natural as it is commonly found along the highway). Also include more plants. This area should look like a forest. The Oak trees are shown 100' wide. This may never happen and if it grows that large, it will take decades. Please mimic nature but at an accelerated pace. Maybe show 9 Oaks. Show a forest in this area.
5. No fence details were included. Please include a detail for the proposed fencing at the lakeside road entrance.
6. Please forward the enlarged planting plan so we can make sure this comment was addressed.
7. ----
8. This comment was not addressed. Please show many more plants, several of which are larger in size at time of planting, to provide screening of the access drive that runs between the two residential properties off Lakeside Dr. Consider a thickly planted hedge of Bottlebrush Buckeye, Aesculus parviflora. It grows in both sun and shade and grows 12'+ in height.
9. Please forward the enlarged planting plan so we can make sure this comment was addressed.
10. Red cedars are pioneer species that require full sun and Gray Dogwood is not deer resistant. Instead propose layers of shade and deer-tolerant species such as Hamamelis virginiana (Witchhazel) and Aesculus parviflora, Bottlebrush Buckeye.
11. Addressed
12. Addressed
13. Addressed

Additional items that must be addressed:

1. Another concern that we discussed is the sloped area between the solar arrays. Please take off the word top. Trees should never be topped! Please remove the Red Maples or show them only at the bottom of the slope as they will get too tall. Consider replacing with 100 Bottlebrush Buckeye, Aesculus parviflora.

2. Please remove note 23 on the planting notes. regarding tree topping. NO trees should be topped.
3. Amend note 20 to read that the guarantee is for a two year period.
4. Amend note 21 to include that the plants will be inspected each growing season and those deemed 25% or more dead or otherwise unfit are to be replaced every growing season as well.

Please call with questions or concerns.

Kind Regards,

*Karen Arent*

Karen Arent Landscape Architect

Phone: (845) 294-9958

Follow me on Instagram: <https://www.instagram.com/karenarentdesigns>

---

**From:** Jeff Lease <jefflease@johnjleaserealtors.com>

**Sent:** Wednesday, January 5, 2022 4:11 PM

**To:** Karen Arent <karenarentdesign@frontier.com>

**Subject:** Darrigo solar farm

ka,

as per our conversation of this afternoon, here are the points that need to be addressed.

on the slope between the two fields:

1. remove 'top' from hillside drawing.
2. do we really want acer rubrum, wattles or other wise when they may grow 75' tall and shadow the solar panels? suggest 100 bottle eye brush, asculaus carbaoforu in its stead.

at meadow and monarch:

3. there was a previous unmet request to screen both sides of the service road with something. there's not much room, but something is better than nothing at all. consider shadblow, bottle brush, or some smaller tree.

84 buffer:

4. that buffer is a bit jejune please beefup a bit, those red maples and white oaks will be underwhelming for a while. please consider some red cedars that provide year-round screening as this is a visual sore spot in the approval process.

patton road buffer:

5. i question the use of red cedar in this area. with the existing trees left i don't see them doing well as an under story tree. how about viburnum or... bottle brush and possibly something a bit more substantial like ...red maple. generally bef this up a bit as it also was a bit contentious in the approval process.

Project Name: 5MW Solar Farm Site Plan for Darrigo Municipality: Newburgh  
 Planning Board No.: \_\_\_\_\_ Date: 12/3/2021

**PRIVATE IMPROVEMENT  
 AND SITE PLAN UNIT PRICES**  
**(Interim Update Dec. 2018)**

<b><u>Description</u></b>	<b><u>Unit</u></b>	<b><u>Unit Cost</u></b>	<b><u>Qty</u></b>	<b><u>Total Cost</u></b>
<b><u>Roadway and Parking Lot</u></b>				
Erosion Control	AC	\$ 2,455.00	33.35	\$ 81,874.25
Silt Fencing	LF	\$ 4.85	8712	\$ 42,253.20
Grading	SY	\$ 2.50		\$ -
Paving & Base (regular construction)	SY	\$ 26.75		\$ -
Paving & Base (heavy-duty construction)	SY	\$ 35.00		\$ -
Tack Coat	SY	\$ 0.75		\$ -
Overlay Existing Pavement (1.5")	SY	\$ 8.75		\$ -
Double Surface Treatment	SY	\$ 8.00		\$ -
Asphalt Paving	TON	\$ 166.75		\$ -
Asphalt Pavement (1.5" top)	SY	\$ 14.60		\$ -
Asphalt Pavement (2" top)	SY	\$ 18.70		\$ -
Asphalt Pavement (3" course)	SY	\$ 28.50		\$ -
Asphalt Pavement (3.5" course)	SY	\$ 33.00		\$ -
Asphalt Pavement (4" course)	SY	\$ 47.00		\$ -
Topsoil & Seeding	SY	\$ 8.00		\$ -
Street Signs (Traffic Control)	EA	\$ 335.00		\$ -
Parking Space Striping	EA	\$ 13.80		\$ -
Handicap symbol	EA	\$ 72.50		\$ -
Parking & Lane Striping	LF	\$ 0.75		\$ -
Painted Striped Island	EA	\$ 53.50		\$ -
Site Plan Stop Bar	EA	\$ 115.00		\$ -
Handicapped Sign & Striping	EA	\$ 300.00		\$ -
Traffic Control Sign	EA	\$ 300.00		\$ -
Concrete Curbing	LF	\$ 24.15		\$ -
Concrete Sidewalk	SY	\$ 53.50		\$ -
Timber Curbing	LF	\$ 17.25		\$ -
Curb (Precast) Bumpers	EA	\$ 100.00		\$ -
Shale Parking (Overflow) Area	SY	\$ 12.10		\$ -
Guiderail	LF	\$ 53.50		\$ -
<b><u>Drainage</u></b>				
Catch Basin	EA	\$ 3,600.00		\$ -
Connection to Existing Catch Basin	EA	\$ 768.00		\$ -
Stormwater Pipe (15") HDPE	LF	\$ 42.25		\$ -
Stormwater Pipe (18") HDPE	LF	\$ 52.00		\$ -
Stormwater Pipe (24") HDPE	LF	\$ 57.50		\$ -
Stormwater Pipe (30") HDPE	LF	\$ 75.00		\$ -
Stormwater Pipe (36") HDPE	LF	\$ 105.00		\$ -
Stormwater Pipe (48") HDPE	LF	\$ 136.50		\$ -
End Section	EA	\$ 535.00		\$ -
Stormwater Pipe (15") RCP	LF	\$ 46.00		\$ -
Stormwater Pipe (18") RCP	LF	\$ 57.50		\$ -
Stormwater Pipe (24") RCP	LF	\$ 84.00		\$ -
Stormwater Pipe (30") RCP	LF	\$ 115.00		\$ -
Stormwater Pipe (36") RCP	LF	\$ 152.00		\$ -

Stormwater Pipe (48") RCP	LF	\$ 238.00	\$	-
Stormwater Pipe (15") CMP	LF	\$ 53.50	\$	-
Stormwater Pipe (18") CMP	LF	\$ 61.50	\$	-
Stormwater Pipe (24") CMP	LF	\$ 75.50	\$	-
Stormwater Pipe (30") CMP	LF	\$ 106.00	\$	-
Stormwater Pipe (36") CMP	LF	\$ 137.50	\$	-
Stormwater Pipe (48") CMP	LF	\$ 192.00	\$	-
Concrete Headwall	EA	\$ 5,348.00	\$	-
Rip Rap Drainage Channel	LF	\$ 22.00	\$	-
Non-lined Drainage Channel	LF	\$ 9.25	\$	-

**Utilities**

Watermain (8")	LF	\$ 71.50	\$	-
Gate Valve (8")	EA	\$ 1,300.00	\$	-
Tapping Sleeve and Valve (8")	EA	\$ 4,615.00	\$	-
Watermain (12")	LF	\$ 88.00	\$	-
Gate Valve (12")	EA	\$ 3,932.50	\$	-
Hydrant Assembly	EA	\$ 5,070.00	\$	-
Sewer Main (8")	LF	\$ 52.00	\$	-
Sewer Main (12")	LF	\$ 65.00	\$	-
Sewer Manholes	EA	\$ 3,068.00	\$	-
Septic Tank	EA	\$ 3,450.00	\$	-
Utility Trench (elec, phone, cable)	LF	\$ 12.00	\$	-

**Misc.**


Landscaping Trees	EA	\$ 333.50	253	\$ 84,375.50
Landscaping Shrubs	EA	\$ 48.25		\$ -
Mulched surface	SY	\$ 4.15		\$ -
Chain link fence (4' black vinyl coated)	LF	\$ 27.15	5536	\$ 150,302.40
Split Rail Fence	LF	\$ 21.25		\$ -
Short Masonry Landscape Walls	LF	\$ 27.15		\$ -
Retaining Walls (modular) 4' height	LF	\$ 107.00		\$ -
Lamppost	EA	\$ 2,000.00		\$ -
Building Mtd. Light	EA	\$ 670.00		\$ -
Waste Enclosure (small)	EA	\$ 1,095.00		\$ -
Dumpster Enclosure (masonry/concrete)	EA	\$ 6,670.00		\$ -
Clear and Grub	AC	\$ 7,995.00	33.35	\$ 266,633.25
Rock Excavation	CY	\$ 162.50		\$ -
Excavation	CY	\$ 16.15		\$ -
Erosion Control Matting	SY	\$ 2.25		\$ -
Bollards (Concrete filled)	EA	\$ 632.50		\$ -

**Other**

Gravel Access Road	SY	2210	\$7.00	\$ 15,470.00
Wooden Guide Rail	LF		\$15.00	\$ -
Level Spreaders	LF		\$12.00	\$ -
Seeding	SY		\$2.00	\$ -
				\$ -
				\$ -
				\$ -
				\$ -
				\$ -
				\$ -
				\$ -


Total \$ 640,908.60

# AMENDED 5 MW AC SOLAR FARM SITE PLAN FOR DARRIGO 84 LAKESIDE AVENUE TOWN OF NEWBURGH – ORANGE COUNTY, N.Y.

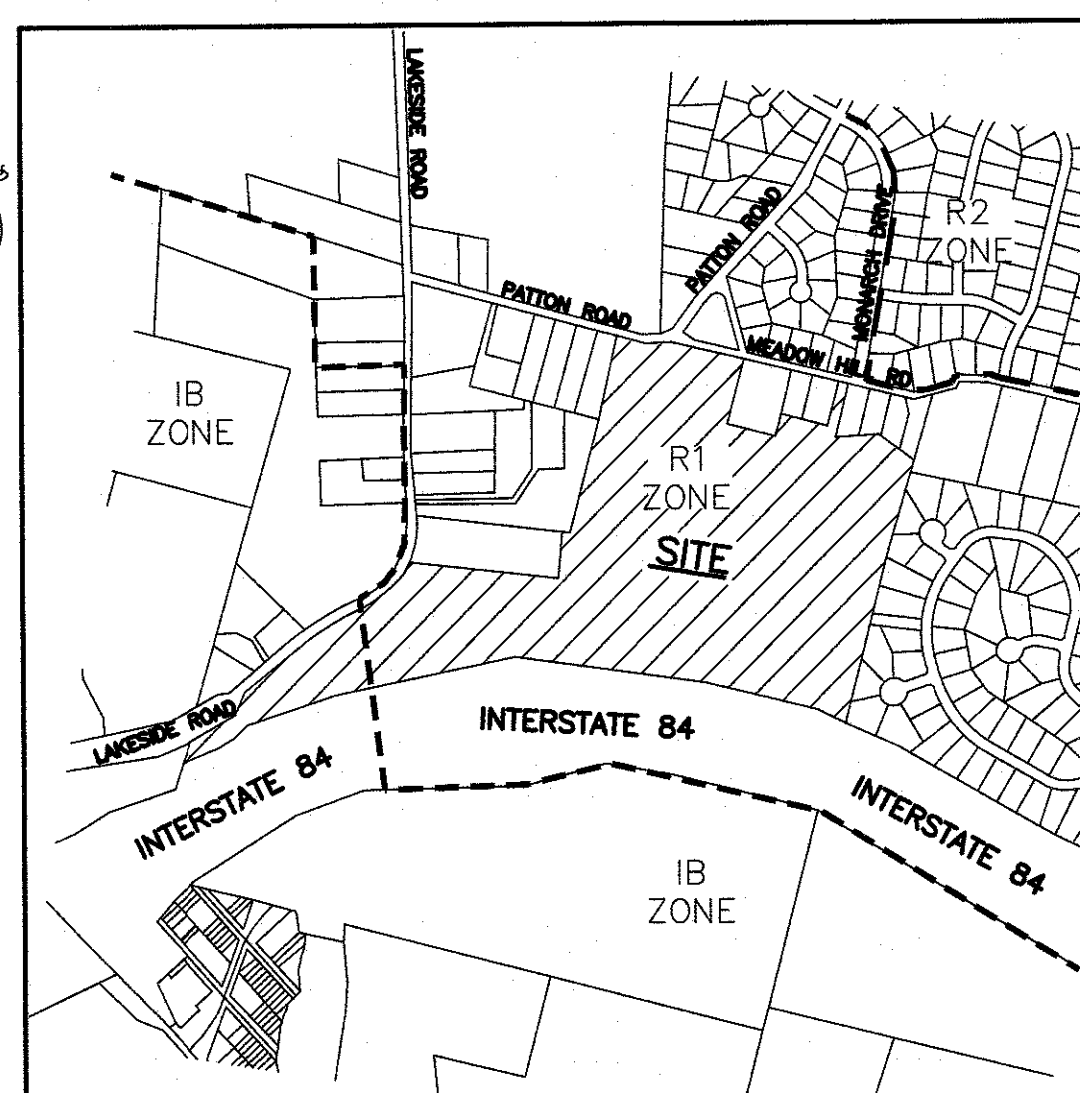

LOCATION MAP  
SCALE: 1"=1000'  
SOURCE: OCWAGIS TAX MAPS

SHEET #	SHEET TITLE	ORIGINAL DATE/ LAST REVISED DATE
01 OF 09	TITLE SHEET	10-30-20/1-18-24
02 OF 09	EXISTING CONDITIONS PLAN	11-12-19/1-18-24
03 OF 09	SITE PLAN	11-12-19/1-18-24
04 OF 09	GRADING AND UTILITY PLAN	11-12-19/1-18-24
05 OF 09	EROSION CONTROL PLAN	11-12-19/1-18-24
06 OF 09	ACCESS ROAD PROFILES 01	11-12-19/1-18-24
07 OF 09	ACCESS ROAD PROFILES 02	11-12-19/1-18-24
08 OF 09	CONSTRUCTION DETAILS	12-16-19/1-18-24
09 OF 09	TURNING DIAGRAMS	11-12-19/1-18-24
L110	LANDSCAPE PLAN	1-22-24
L111	LANDSCAPE PLAN ENLARGEMENTS	1-22-24
L501	ENTRANCE PIER ELEVATIONS	1-22-24
L502	ENTRANCE FEATURE DETAILS	1-22-24

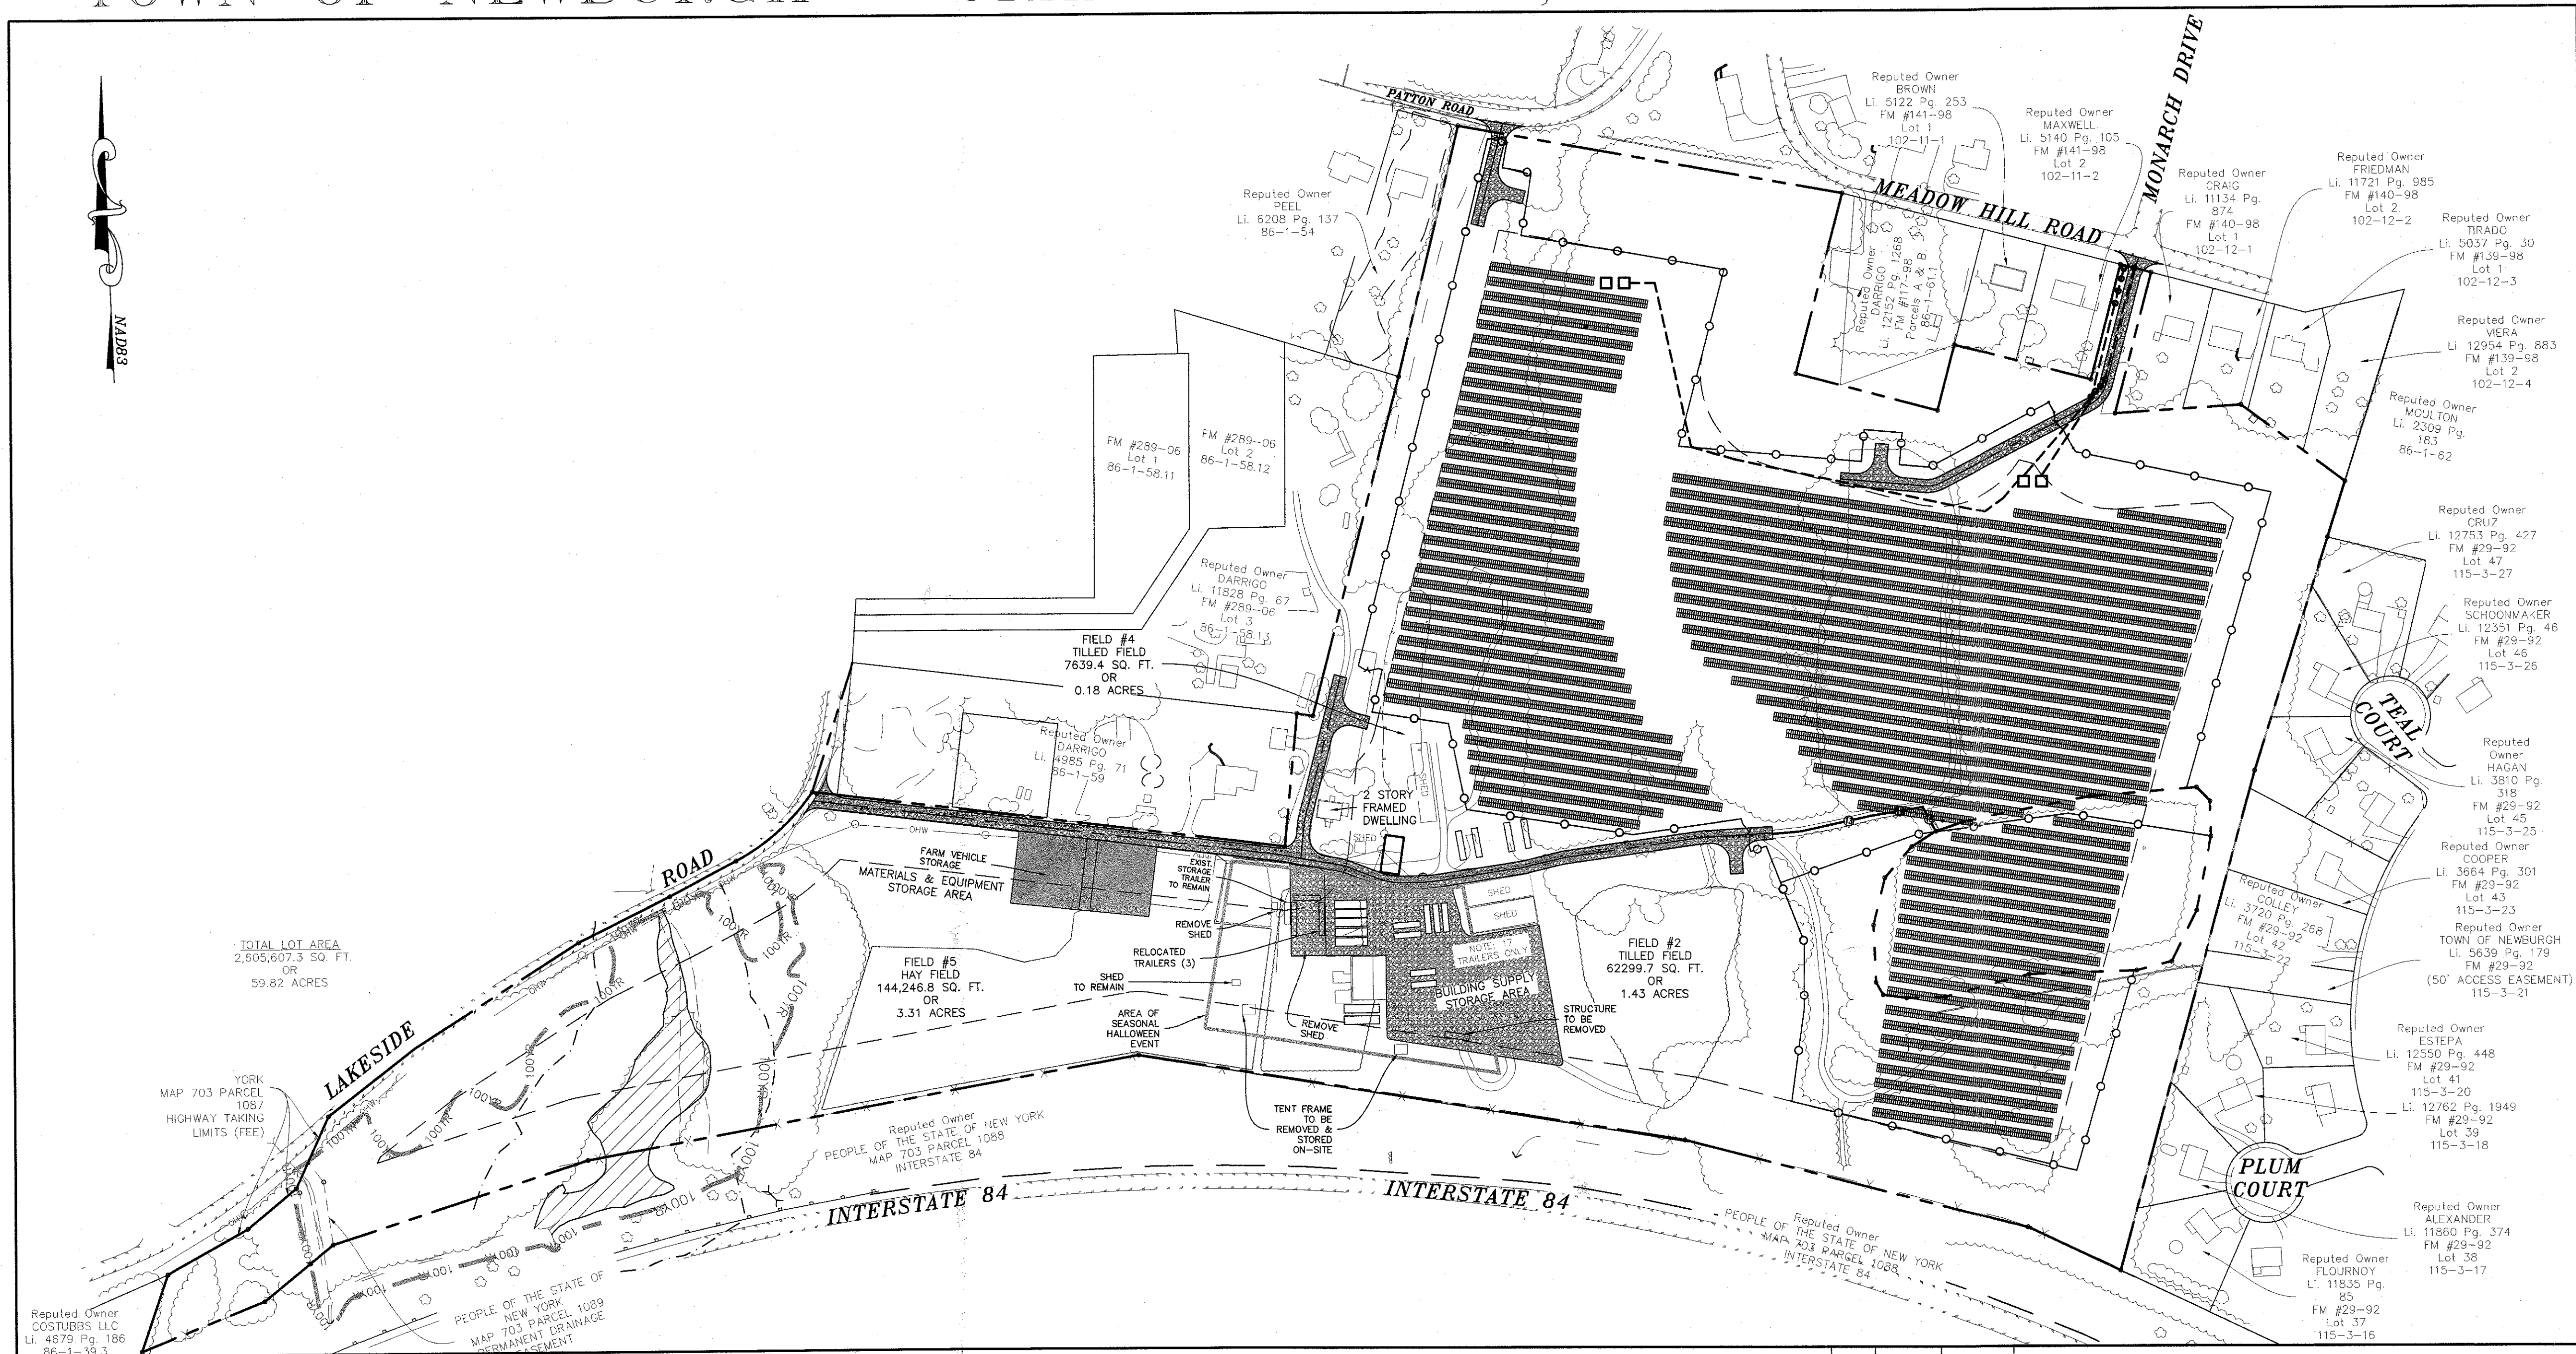

Reputed Owner  
COSTUBBS LLC  
LI. 4679 Pg. 186  
86-1-33.3


TOTAL LOT AREA  
2,605,607.3 SQ. FT.  
OR  
59.82 ACRES

**RECORD OWNER & APPLICANT**  
OWNER:  
FRANK DARRIGO REVOCABLE TRUST  
84 LAKESIDE RD  
NEWBURGH NY 12550  
  
APPLICANT:  
JEFFREY LEASE  
597 GRAND AVENUE  
NEWBURGH, NY 12550

- REFERENCES:**
- TOWN OF NEWBURGH TAX MAP 86-1-96.
  - BOUNDARY AND PLANIMETRIC INFORMATION ON THIS PLAN HAS BEEN TAKEN FROM A SURVEY ENTITLED "SURVEY PREPARED FOR F&T DARRIGO" DATED MAY 13, 2012 AS PREPARED BY DJ SCALZO ASSOCIATES ENGINEERING AND PLANNING, 57 FIFTH AVENUE, NEWBURGH, NEW YORK 12550.
  - SOLAR ARRAY DESIGN INFORMATION ON THIS PLAN HAS BEEN TAKEN FROM A PLAN ENTITLED "MOUNTAIN GARDENS, LLC" DATED JUNE 5, 2019 AS PREPARED BY ENTER SOLAR, 805 THIRD AVENUE, 20TH FLOOR, NEW YORK, NY 1002.
  - TOPOGRAPHIC INFORMATION SHOWN ON THIS PLAN HAS BEEN TAKEN FROM AN AERIAL SURVEY PREPARED BY GEODETIC ASSOCIATES IN 2005.
  - TOPOGRAPHIC INFORMATION IN THE REMEDIATION AREA HAS BEEN TAKEN FROM A SURVEY PREPARED BY CHRISTOPHER M. COPPENS OF COPPENS LAND SURVEYING.

- SITE PLAN APPROVAL NOTES:**
- ORIGINAL ZONING BOARD OF APPEALS USE VARIANCE GRANTED ON NOVEMBER 26, 2019.
  - AMENDED ZONING BOARD OF APPEALS USE VARIANCE AND PRE-EXISTING NON-CONFORMING USES THAT CURRENTLY EXIST ON THE SITE TO REMAIN ON SEPTEMBER 24, 2020.
  - PLANNING BOARD ORIGINAL RESOLUTION OF APPROVAL – SITE PLAN APPROVAL DATED APRIL 15, 2021.


TITLE SHEET  
SCALE: 1"=150'

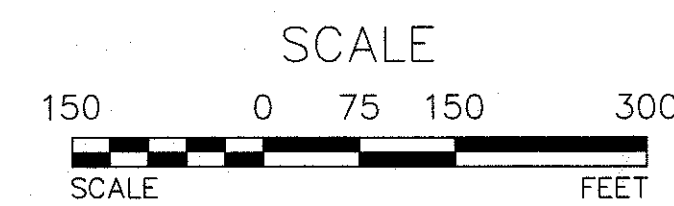

#REV.	BY	DATE	DESCRIPTION
#5	MM	1/18/24	PHASING PLAN PREPARATION
#4	MM	10/12/23	DEC HW FENCE REMOVED ON PROPOSED SOLAR FARM PLANS
#3	MM	3/16/21	PER 3/16/21 SITE VISIT
#2	MM	2/23/21	PER WS COMMENTS
#1	MM	1/11/21	PER PB COMMENTS

THIS SHEET IS NOT VALID WITHOUT ALL OF THE SHEETS THAT COMPRISE THE SET

**ARDEN CONSULTING ENGINEERS, PLLC**  
P.O. BOX 340 MONROE, N.Y.  
TEL: (845) 782-8114  
WWW.ARDENCONSULTING.NET

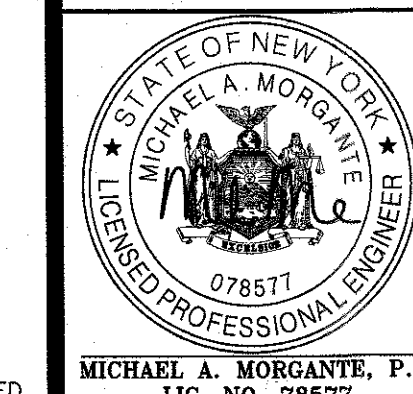


AMENDED 5 MW AC SOLAR FARM SITE PLAN FOR  
DARRIGO  
84 LAKESIDE AVENUE  
TOWN OF NEWBURGH – ORANGE COUNTY, N.Y.

**TITLE SHEET**

JOB#: 18-014  
SCALE: AS NOTED  
ORIGINAL DATE: 10-30-20  
DRAWN: MM  
CHECKED: MM  
SHEET NO. 01 of 09

WARNING- IT IS A VIOLATION OF NEW YORK EDUCATIONAL LAW, SECTION 7209.2, FOR ANY PERSON, UNLESS ACTING UNDER THE DIRECTION OF A LICENSED PROFESSIONAL ENGINEER OR LAND SURVEYOR, TO ALTER THIS DOCUMENT IN ANY WAY. IF ALTERED, THE ALTERING PERSON SHALL COMPLY WITH THE REQUIREMENTS OF NEW YORK EDUCATIONAL LAW, SECTION 7209.2

ONLY MAPS WITH EMBOSSED SEALS ARE GENUINE COPIES OF THE ORIGINAL WORK AND OPINION. MAPS NOT BEARING EMBOSSED SEALS SHOULD NOT BE RELIED UPON SINCE OTHER THAN EMBOSSED-SEAL COPIES MAY CONTAIN UNAUTHORIZED AND UNDETECTABLE MODIFICATIONS, DELETIONS, ADDITIONS AND CHANGES.

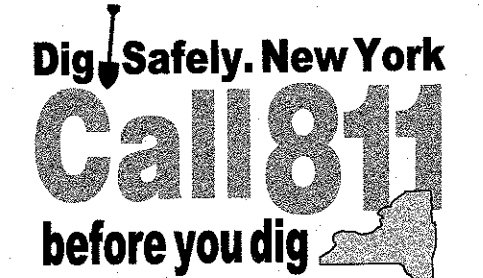




MADRS

**ZONING NOTES:**

1. NORTHERN & EASTERN ZONING SETBACKS WERE ESTABLISHED BY THE ZONING BOARD OF APPEALS.
2. THE EXISTING 50' OF TREE LINE AT THE PROPERTY LINE SHALL REMAIN.
3. PARCEL IS LOCATED WITHIN THE R1 ZONING DISTRICT.

**SITE PLAN NOTES:**

1. THE SEASONAL HALLOWEEN EVENT IS A MULTI-ATTRACTION EXPERIENCE WHICH OPERATES ON WEEKENDS ONLY BEGINNING THE SECOND WEEK OF SEPTEMBER AND RUNNING THROUGH MID NOVEMBER. HOURS OF OPERATION FOR THIS EVENT ARE 7PM TO MIDNIGHT. THE NYS DEPARTMENT OF LABOR REQUIRES AN ANNUAL PERMIT TO OPERATE EACH YEAR. THE TOWN OF NEWBURGH SHALL BE PROVIDED WITH A COPY OF THIS PERMIT EACH YEAR AND SHALL BE PERMITTED TO CONDUCT THEIR OWN INSPECTIONS AS REQUIRED. THE SEASONAL HALLOWEEN EVENT SHALL BE ERECTED AND SUBSEQUENTLY TAKEN DOWN FOR STORAGE EACH YEAR.
2. A DEMOLITION PERMIT MUST BE OBTAINED FROM THE TOWN OF NEWBURGH PRIOR TO THE DEMOLITION OF REMOVAL OF ANY STRUCTURE.
3. TRAILERS AND OTHER STORAGE STRUCTURES TO BE RELOCATED SHALL REMAIN IN USE EACH YEAR.

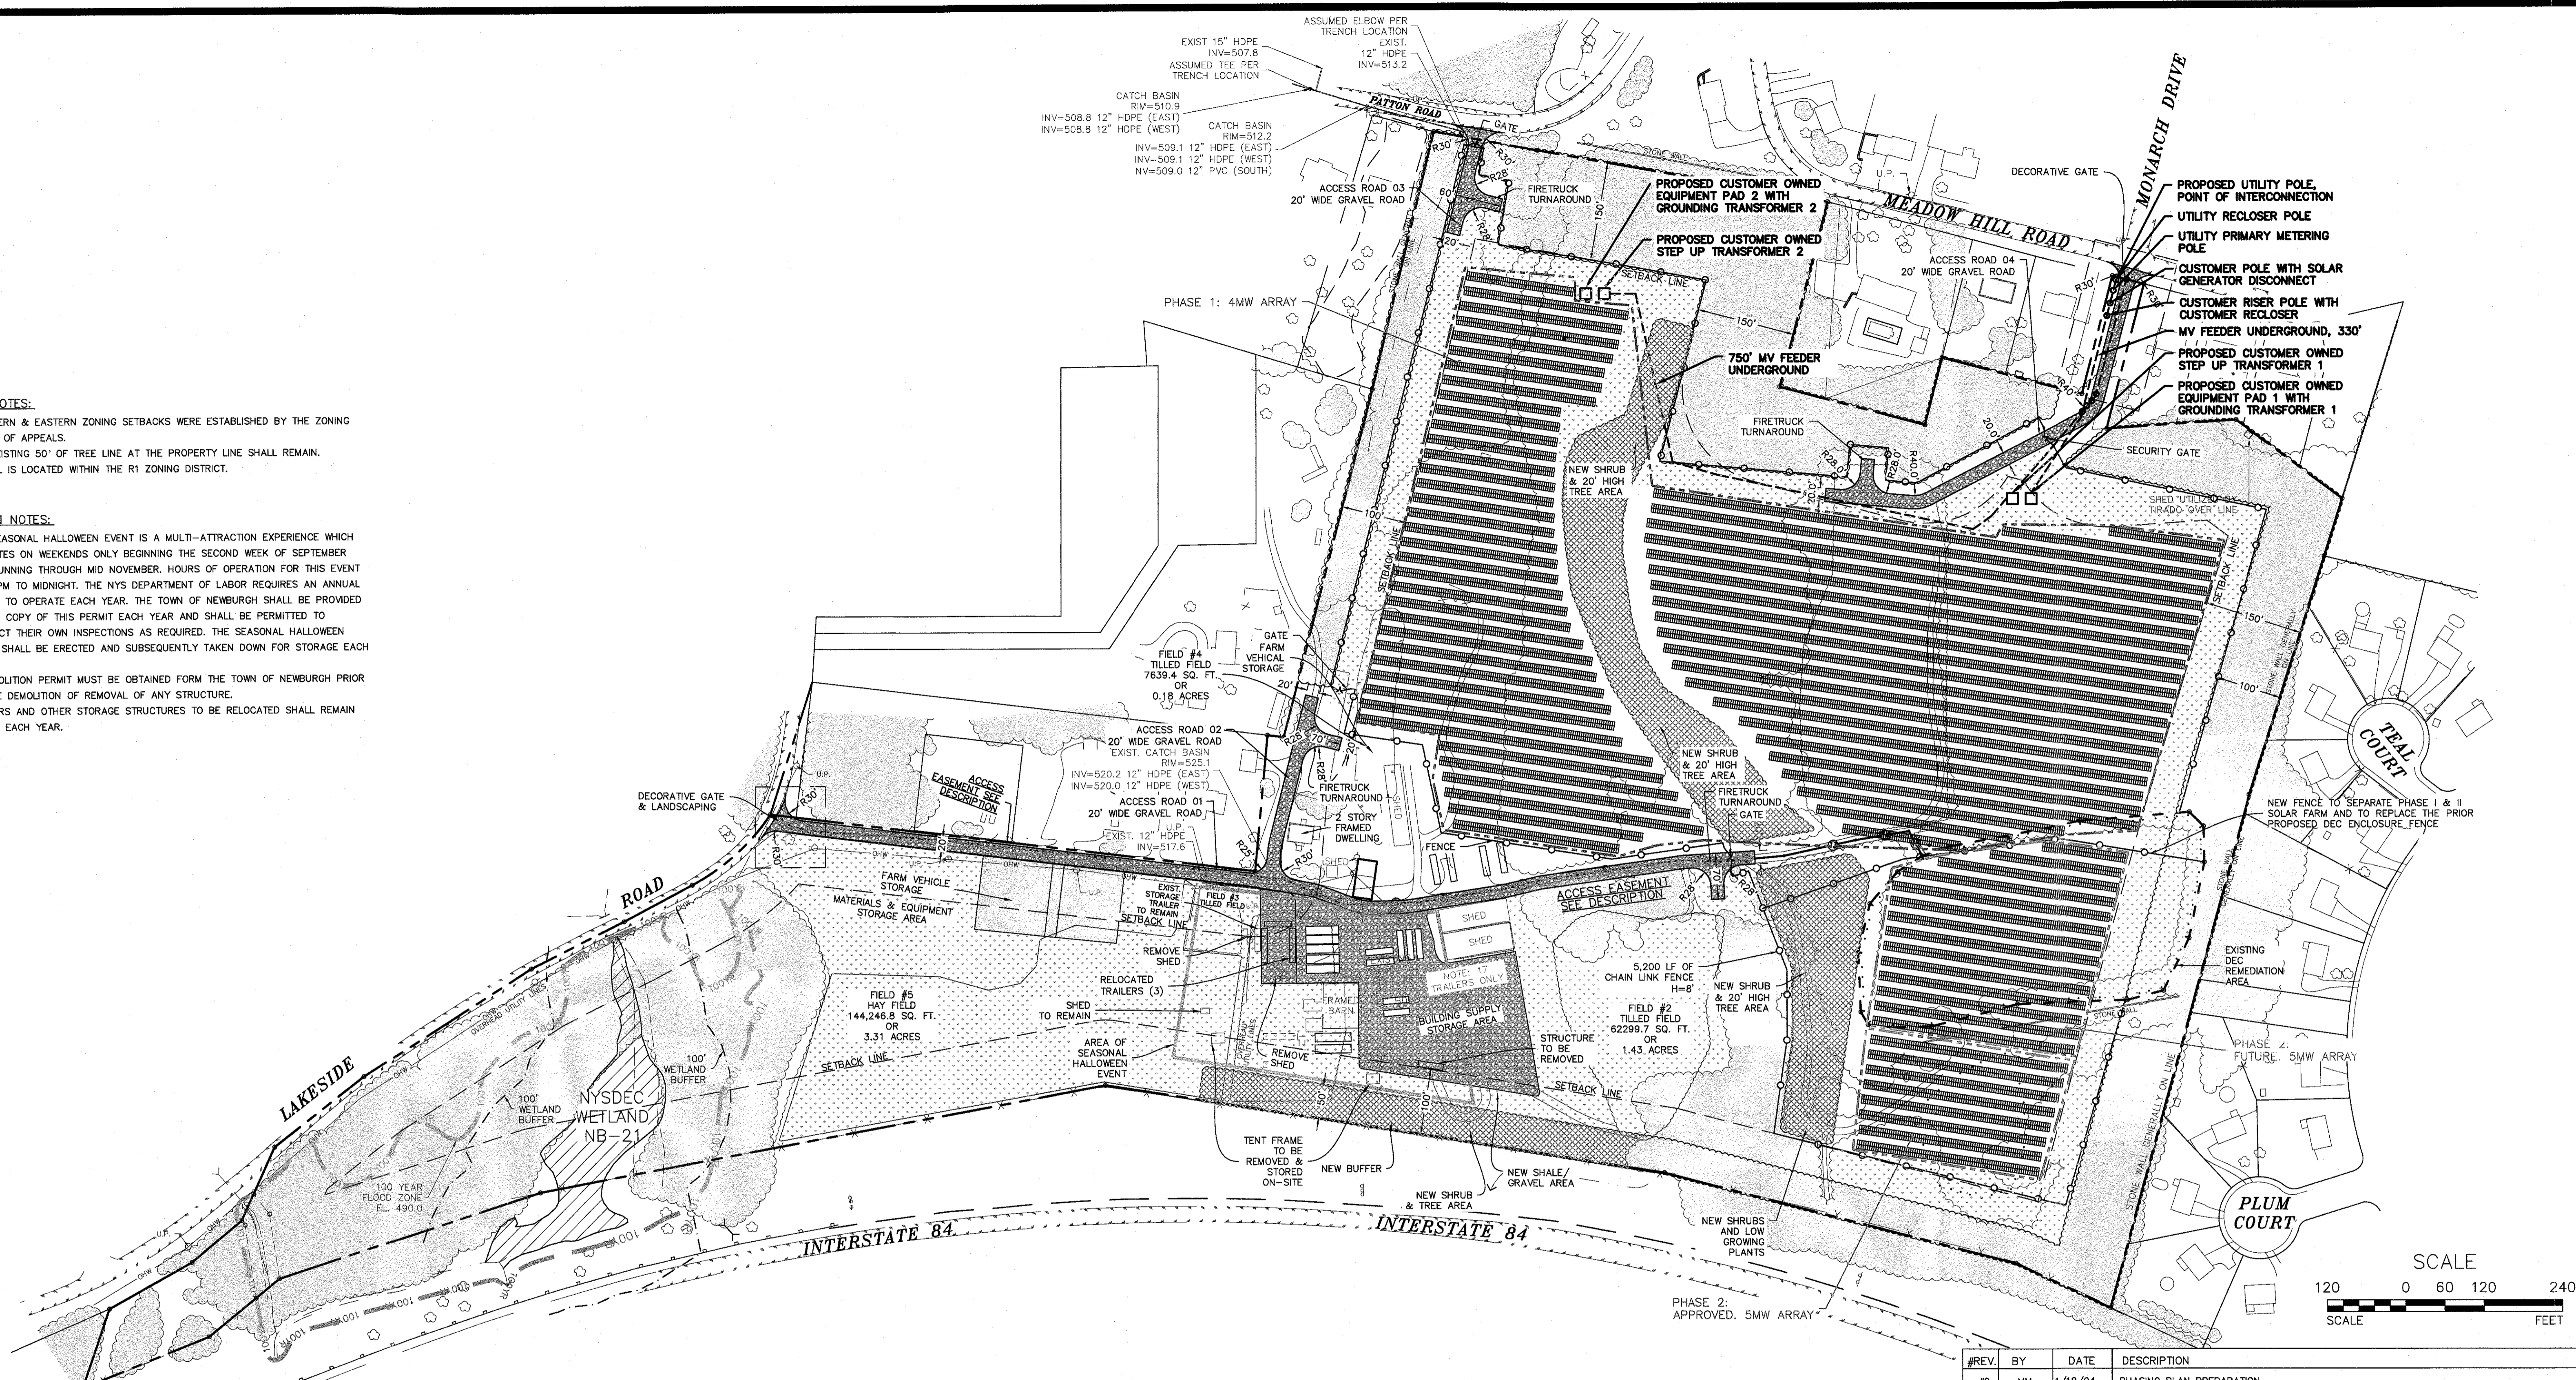

**SITE PLAN**  
SCALE: 1"=120'

**OWNER'S CONSENT NOTE:**  
THE UNDERSIGNED OWNERS OF THE PROPERTY HEREON STATE THAT THEY ARE FAMILIAR WITH THIS PLAN, ITS CONTENTS AND ITS LEGENDS AND HEREBY CONSENT TO ALL SAID TERMS AND CONDITIONS AS STATED HEREON AND TO THE FILING OF THIS PLAN IN THE OFFICE OF THE CLERK OF THE COUNTY OF ORANGE, IF SO REQUIRED.

SIGNATURE - OWNER(S) TAX LOT 86-1-96

**LEGEND:**

- 590 --- EXISTING MAJOR CONTOUR
- --- EXISTING MINOR CONTOUR
- --- EXISTING EDGE OF PAVEMENT
- --- EXISTING PROPERTY LINE
- --- EXISTING ADJACENT PROPERTY LINE
- --- EXISTING BUILDING LINE
- --- EXISTING IRON ROD FOUND
- --- EXISTING LIGHT POLE
- --- EXISTING STONE WALL
- --- EXISTING TREETLINE
- --- EXISTING GRAVEL DRIVEWAY
- --- EXISTING GUARDRAIL
- --- EXISTING TREES
- --- EXISTING SEWER MANHOLE
- --- EXISTING WETLAND
- --- NEW SHRUB & TREE AREA
- --- EXISTING VEGETATION TO REMAIN
- --- EXISTING GRASS
- --- PROPOSED SOLAR
- --- PROPOSED GRAVEL ACCESS ROAD
- --- PROPOSED ZONING SETBACKS
- --- PROPOSED FENCE

#REV.	BY	DATE	DESCRIPTION
#9	MM	1/18/24	PHASING PLAN PREPARATION
#8	MM	10/12/23	DEC HW FENCE REMOVED ON PROPOSED SOLAR FARM PLANS
#7	MM	3/16/21	PER 3/16/21 SITE VISIT
#6	MM	2/23/21	PER WS COMMENTS
#5	MM	1/11/21	PER PB COMMENTS
#4	MM	10/30/20	FINAL PLAN PREPARATION
#3	MM	10/23/20	REVISIONS PER ZBA MTG.
#2	MM	2/11/20	REVISIONS PER 2/4/20 PB MTG.
#1	MM	1/31/20	UTILITY POLE RELOCATION FOR INTERCONNECTION POINT

THIS SHEET IS NOT VALID WITHOUT ALL OF THE SHEETS THAT COMPRISE THE SET

**ARDEN CONSULTING ENGINEERS, PLLC**  
P.O. BOX 340 MONROE, N.Y.  
TEL: (845) 782-8114  
[WWW.ARDENCONSULTING.NET](http://WWW.ARDENCONSULTING.NET)

**AMENDED 5 MW AC SOLAR FARM SITE PLAN FOR DARRIGO**  
84 LAKESIDE AVENUE  
TOWN OF NEWBURGH - ORANGE COUNTY, N.Y.


JOB#: 18-014  
SCALE: AS NOTED  
ORIGINAL DATE: 11-12-19  
DRAWN: MM  
CHECKED: MM  
SHEET NO. 03 of 09

**SITE PLAN**

MICHAEL A. MORGANTE, P.E.  
LIC. NO. 78577


WARNING- IT IS A VIOLATION OF NEW YORK EDUCATIONAL LAW, SECTION 7209.2, FOR ANY PERSON, UNLESS ACTING UNDER THE DIRECTION OF A LICENSED PROFESSIONAL ENGINEER OR LAND SURVEYOR, TO ALTER THIS DOCUMENT IN ANY WAY, IF ALTERED, THE ALTERING PERSON SHALL COMPLY WITH THE REQUIREMENTS OF NEW YORK EDUCATIONAL LAW, SECTION 7209.2

ONLY MAPS WITH EMBOSSED SEALS ARE GENUINE COPIES OF THE ORIGINAL WORK AND OPINION. MAPS NOT BEARING EMBOSSED SEALS SHOULD NOT BE RELIED UPON SINCE OTHER THAN EMBOSSED-SEAL COPIES MAY CONTAIN UNAUTHORIZED AND UNDETECTABLE MODIFICATIONS, DELETIONS, ADDITIONS AND CHANGES.

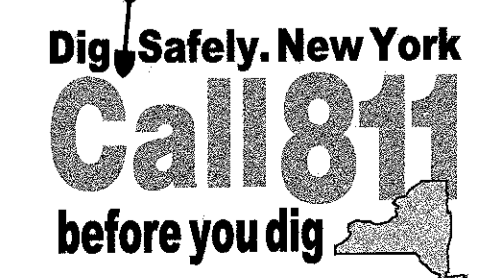




48" SAFETY FENCE, 72" T-POSTS	
SAF12	48" ORANGE FENCE, 12 FEET O.C.
SAF11	48" ORANGE FENCE, 11 FEET O.C.
SAF10	48" ORANGE FENCE, 10 FEET O.C.
SAF9	48" ORANGE FENCE, 9 FEET O.C.
SAF8	48" ORANGE FENCE, 8 FEET O.C.
SAF7	48" ORANGE FENCE, 7 FEET O.C.
SAF6	48" ORANGE FENCE, 6 FEET O.C.

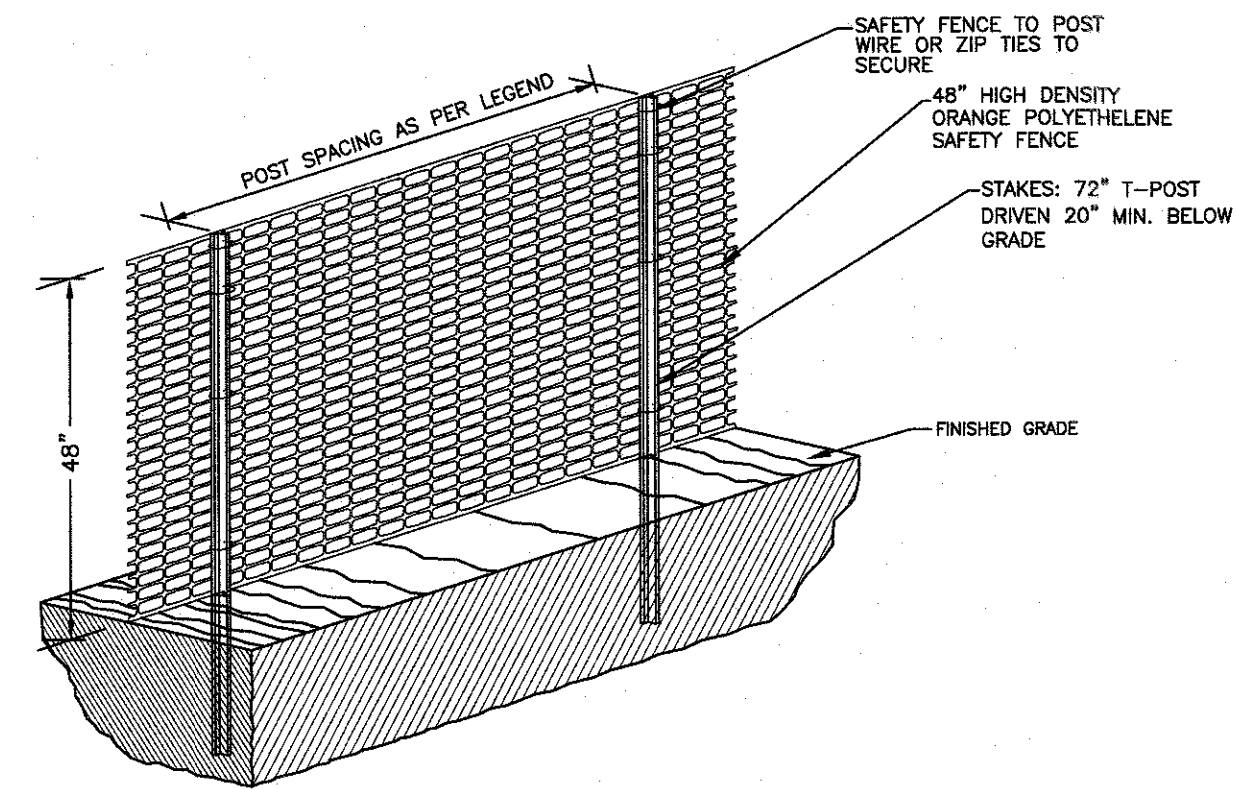


SENSITIVE AREA/TREE PROTECTION  
NOT TO SCALE

- NOTES:
1. ALL SENSITIVE AREAS SHALL BE PROTECTED AS PER PLAN.
  2. ALL TREES IN THE CONSTRUCTION AREA NOT SPECIFICALLY DESIGNATED FOR REMOVAL SHALL BE PRESERVED AND PROTECTED WITH HIGH VISIBILITY FENCE AS PER PLAN.
  3. WHEN PRACTICABLE, INSTALL HIGH VISIBILITY 3 FEET OUTSIDE OF THE DRIP LINE OF THE TREE.
  4. SAFETY FENCE SHOULD BE FASTENED SECURELY TO THE T-POSTS.
  5. THE FENCING MUST REMAIN IN PLACE DURING ALL PHASES OF CONSTRUCTION; ANY CHANGE OF THE PROTECTIVE FENCING MUST BE APPROVED.
  6. FENCE SHALL BE MANUFACTURED BY EROSION RUNNER OR EQUAL.

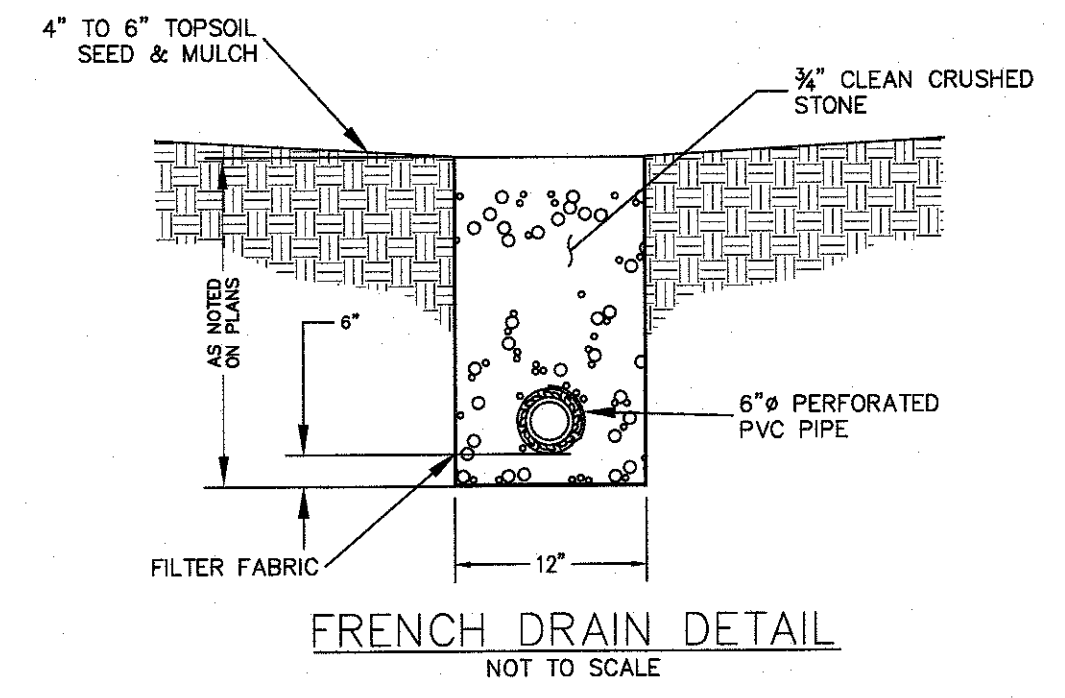

FRENCH DRAIN DETAIL  
NOT TO SCALE

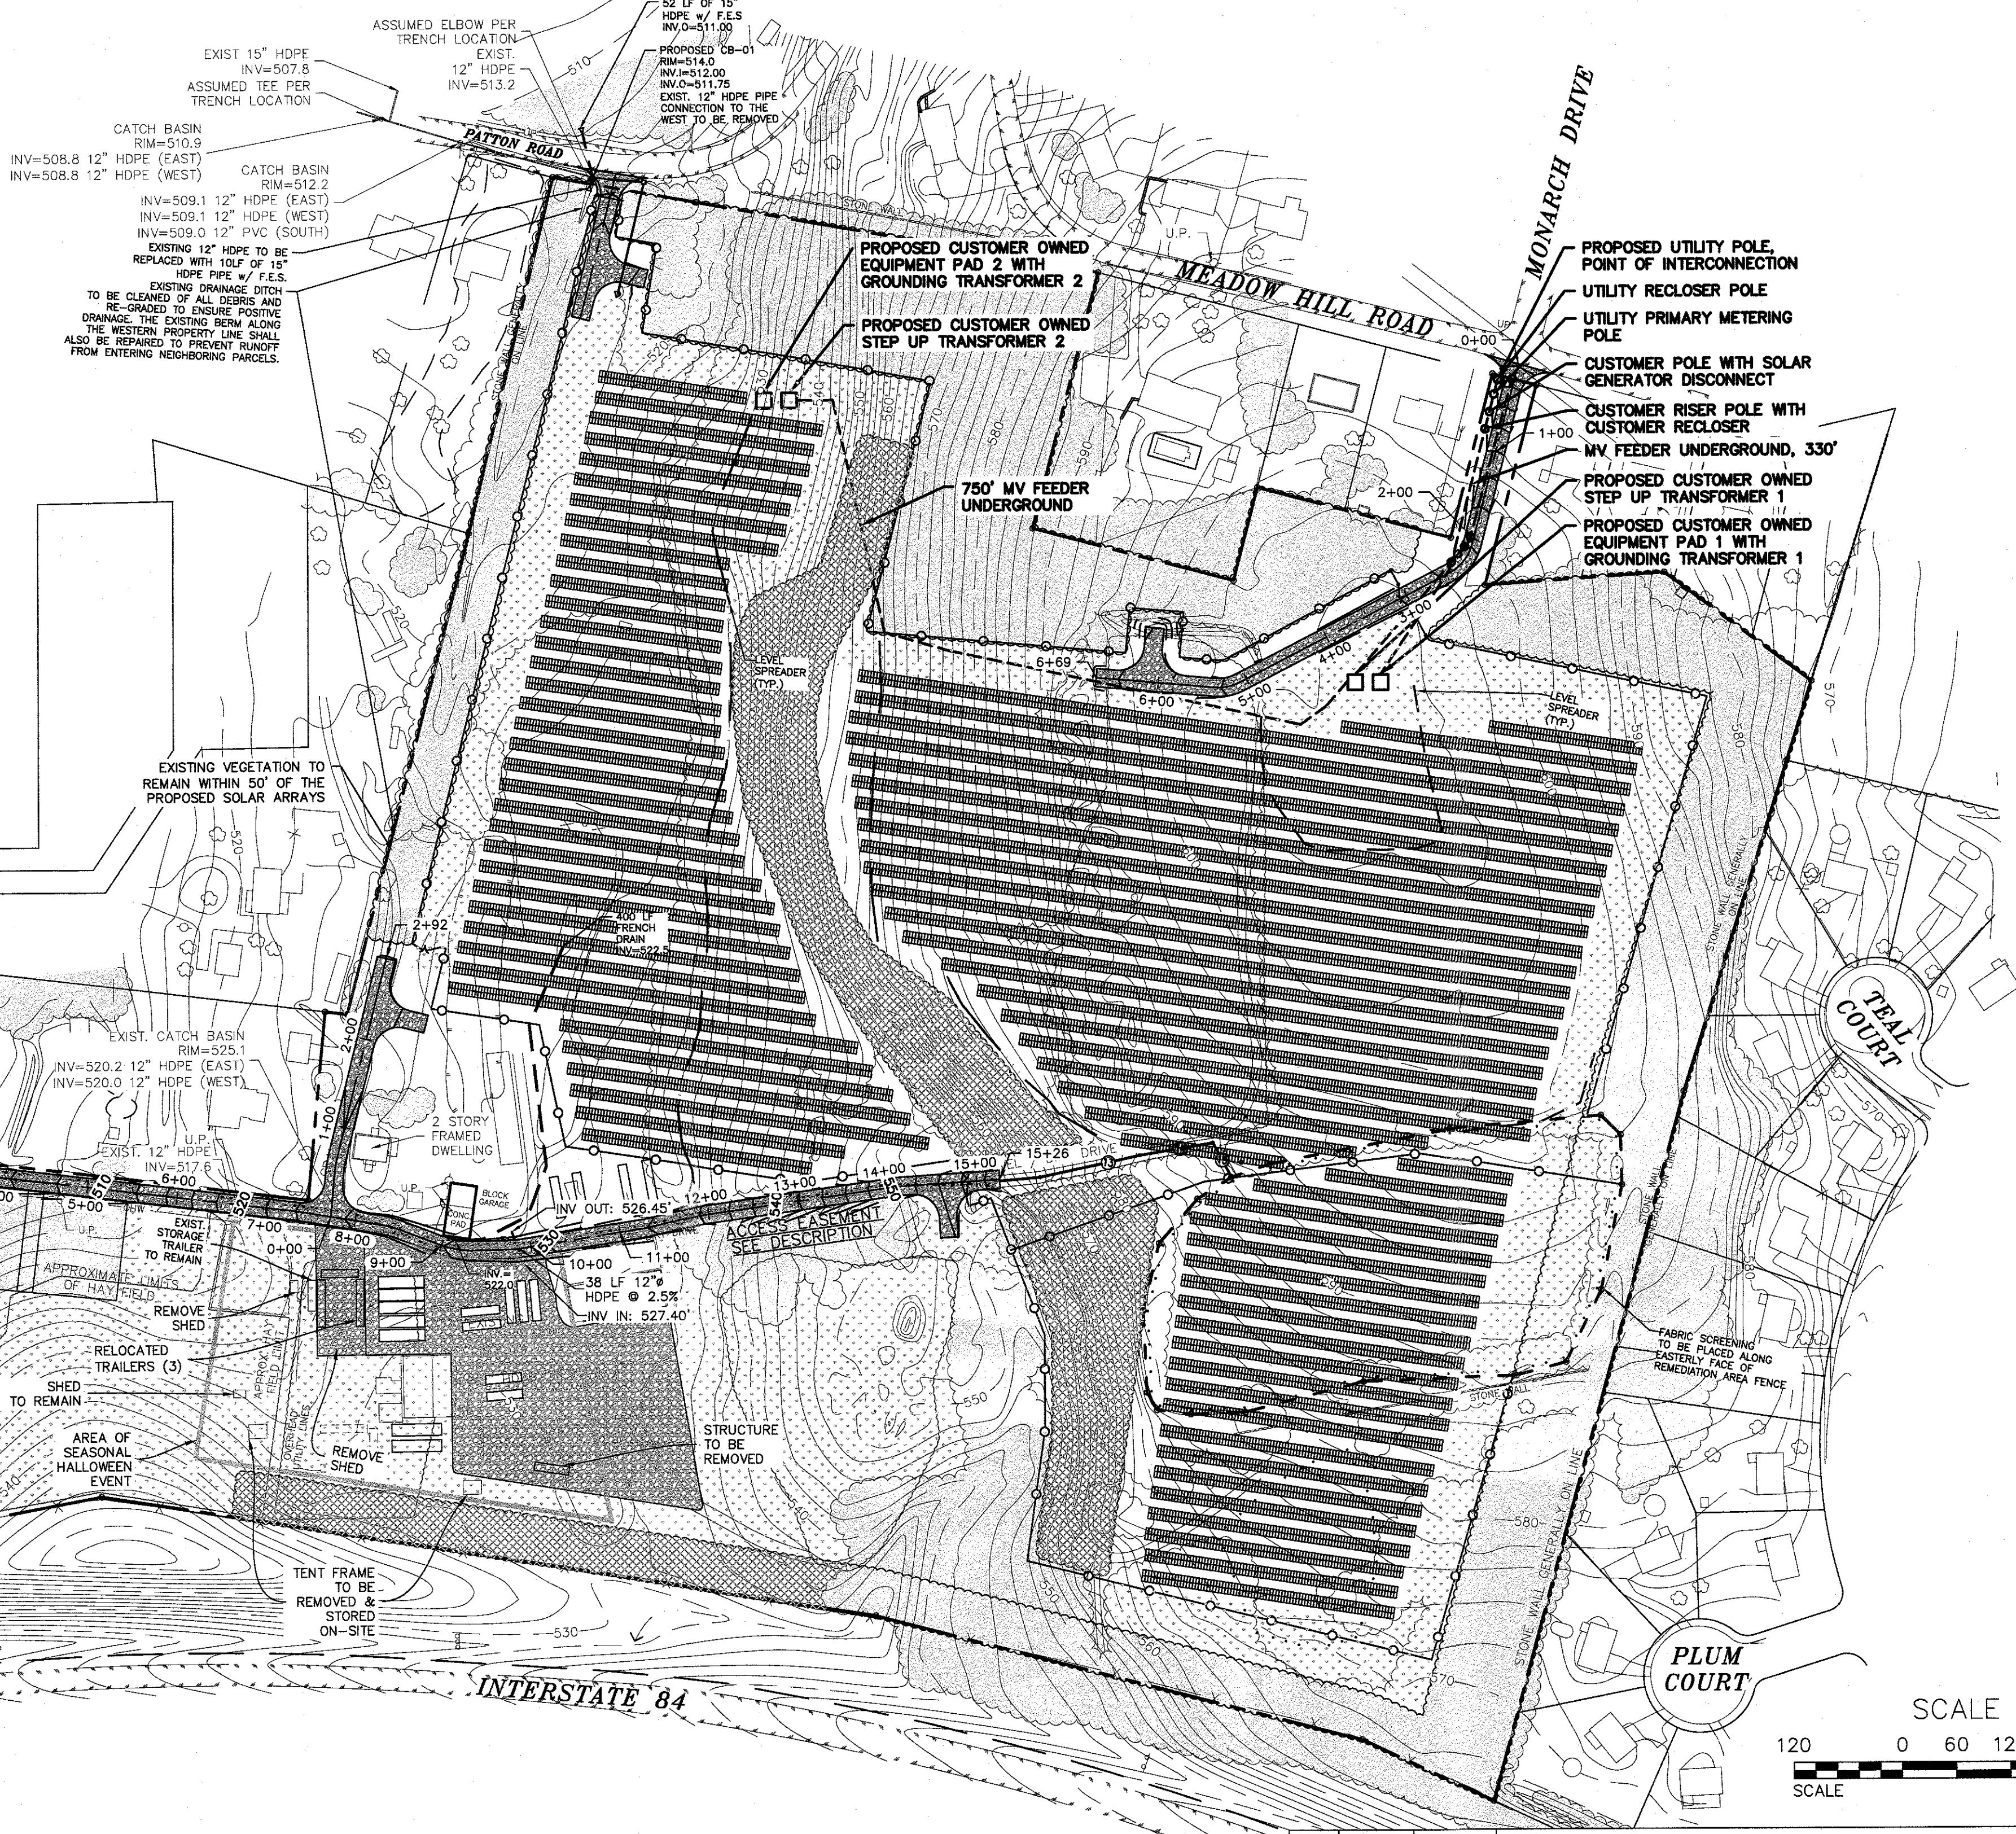


GRADING AND UTILITY PLAN  
SCALE: 1"=120'

- NOTES:
1. APPROXIMATELY 22 ACRES OF TREE CLEARING IS PROPOSED.
  2. LIMITS OF DISTURBANCE AREA = 33.35 ACRES
  3. NO TREE REMOVAL SHALL OCCUR FROM APRIL 1 - OCTOBER 31 TO MITIGATE POTENTIAL IMPACTS ON INDIANA BAT.
  4. PRIOR TO THE COMMENCEMENT OF CONSTRUCTION THE LIMITS OF CLEARING WILL BE CLEARLY DEMARCATED ON THE SITE WITH ORANGE CONSTRUCTION FENCING.

- 600 — PROPOSED MAJOR CONTOUR
- 602 — PROPOSED MINOR CONTOUR
- ▨ PROPOSED SOLAR
- ▨ PROPOSED GRAVEL ACCESS ROAD
- — — PROPOSED ZONING SETBACKS
- ○ PROPOSED FENCE
- ▨ EXISTING VEGETATION TO REMAIN
- ▨ EXISTING GRASS
- ▨ NEW SHRUB & TREE AREA

- LEGEND:
- 590 — — — EXISTING MAJOR CONTOUR
  - — — EXISTING MINOR CONTOUR
  - — — EXISTING EDGE OF PAVEMENT
  - — — EXISTING ADJACENT PROPERTY LINE
  - — — EXISTING BUILDING LINE
  - EXISTING IRON ROD FOUND
  - EXISTING LIGHT POLE
  - EXISTING STONE WALL
  - EXISTING TREELINE
  - — — EXISTING GRAVEL DRIVEWAY
  - — — EXISTING GUARDRAIL
  - EXISTING TREES
  - EXISTING SEWER MANHOLE
  - ▨ EXISTING WETLAND

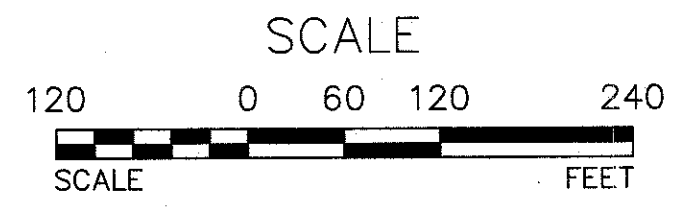

WARNING- IT IS A VIOLATION OF NEW YORK EDUCATIONAL LAW, SECTION 7209.2, FOR ANY PERSON, UNLESS ACTING UNDER THE DIRECTION OF A LICENSED PROFESSIONAL ENGINEER OR LAND SURVEYOR, TO ALTER THIS DOCUMENT IN ANY WAY. IF ALTERED, THE ALTERING PERSON SHALL COMPLY WITH THE REQUIREMENTS OF NEW YORK EDUCATIONAL LAW, SECTION 7209.2

ONLY MAPS WITH EMBOSSED SEALS ARE GENUINE COPIES OF THE ORIGINAL WORK AND OPINION. MAPS NOT BEARING EMBOSSED SEALS SHOULD NOT BE RELIED UPON SINCE OTHER THAN EMBOSSED-SEAL COPIES MAY CONTAIN UNAUTHORIZED AND UNDETECTABLE MODIFICATIONS, DELETIONS, ADDITIONS AND CHANGES.

Dig Safely. New York  
Call 811  
before you dig

#REV.	BY	DATE	DESCRIPTION
#8	MM	1/18/24	PHASING PLAN PREPARATION
#7	MM	10/12/23	DEC HW FENCE REMOVED ON PROPOSED SOLAR FARM PLANS
#6	MM	3/16/21	PER 3/16/21 SITE VISIT
#5	MM	2/23/21	PER WS COMMENTS
#4	MM	1/11/21	PER PB COMMENTS
#3	MM	10/30/20	FINAL PLAN PREPARATION
#2	MM	1/24/20	REVISION PER MHE 1/2/20 COMMENT LETTER
#1	MM	12/16/19	ADDITION OF STORMWATER FACILITIES

ARDEN CONSULTING ENGINEERS, PLLC  
P.O. BOX 340 MONROE, N.Y.  
TEL: (845) 782-8114  
WWW.ARDENCONSULTING.NET


AMENDED 5 MW AC SOLAR FARM SITE PLAN FOR DARRIGO  
84 LAKESIDE AVENUE  
TOWN OF NEWBURGH - ORANGE COUNTY, N.Y.

GRADING AND UTILITY PLAN


MICHAEL A. MORGAN, P.E.  
LIC. NO. 78577

JOB#: 18-014  
SCALE: AS NOTED  
ORIGINAL DATE: 11-12-19  
DRAWN: MM  
CHECKED: MM  
SHEET NO. 04 of 09



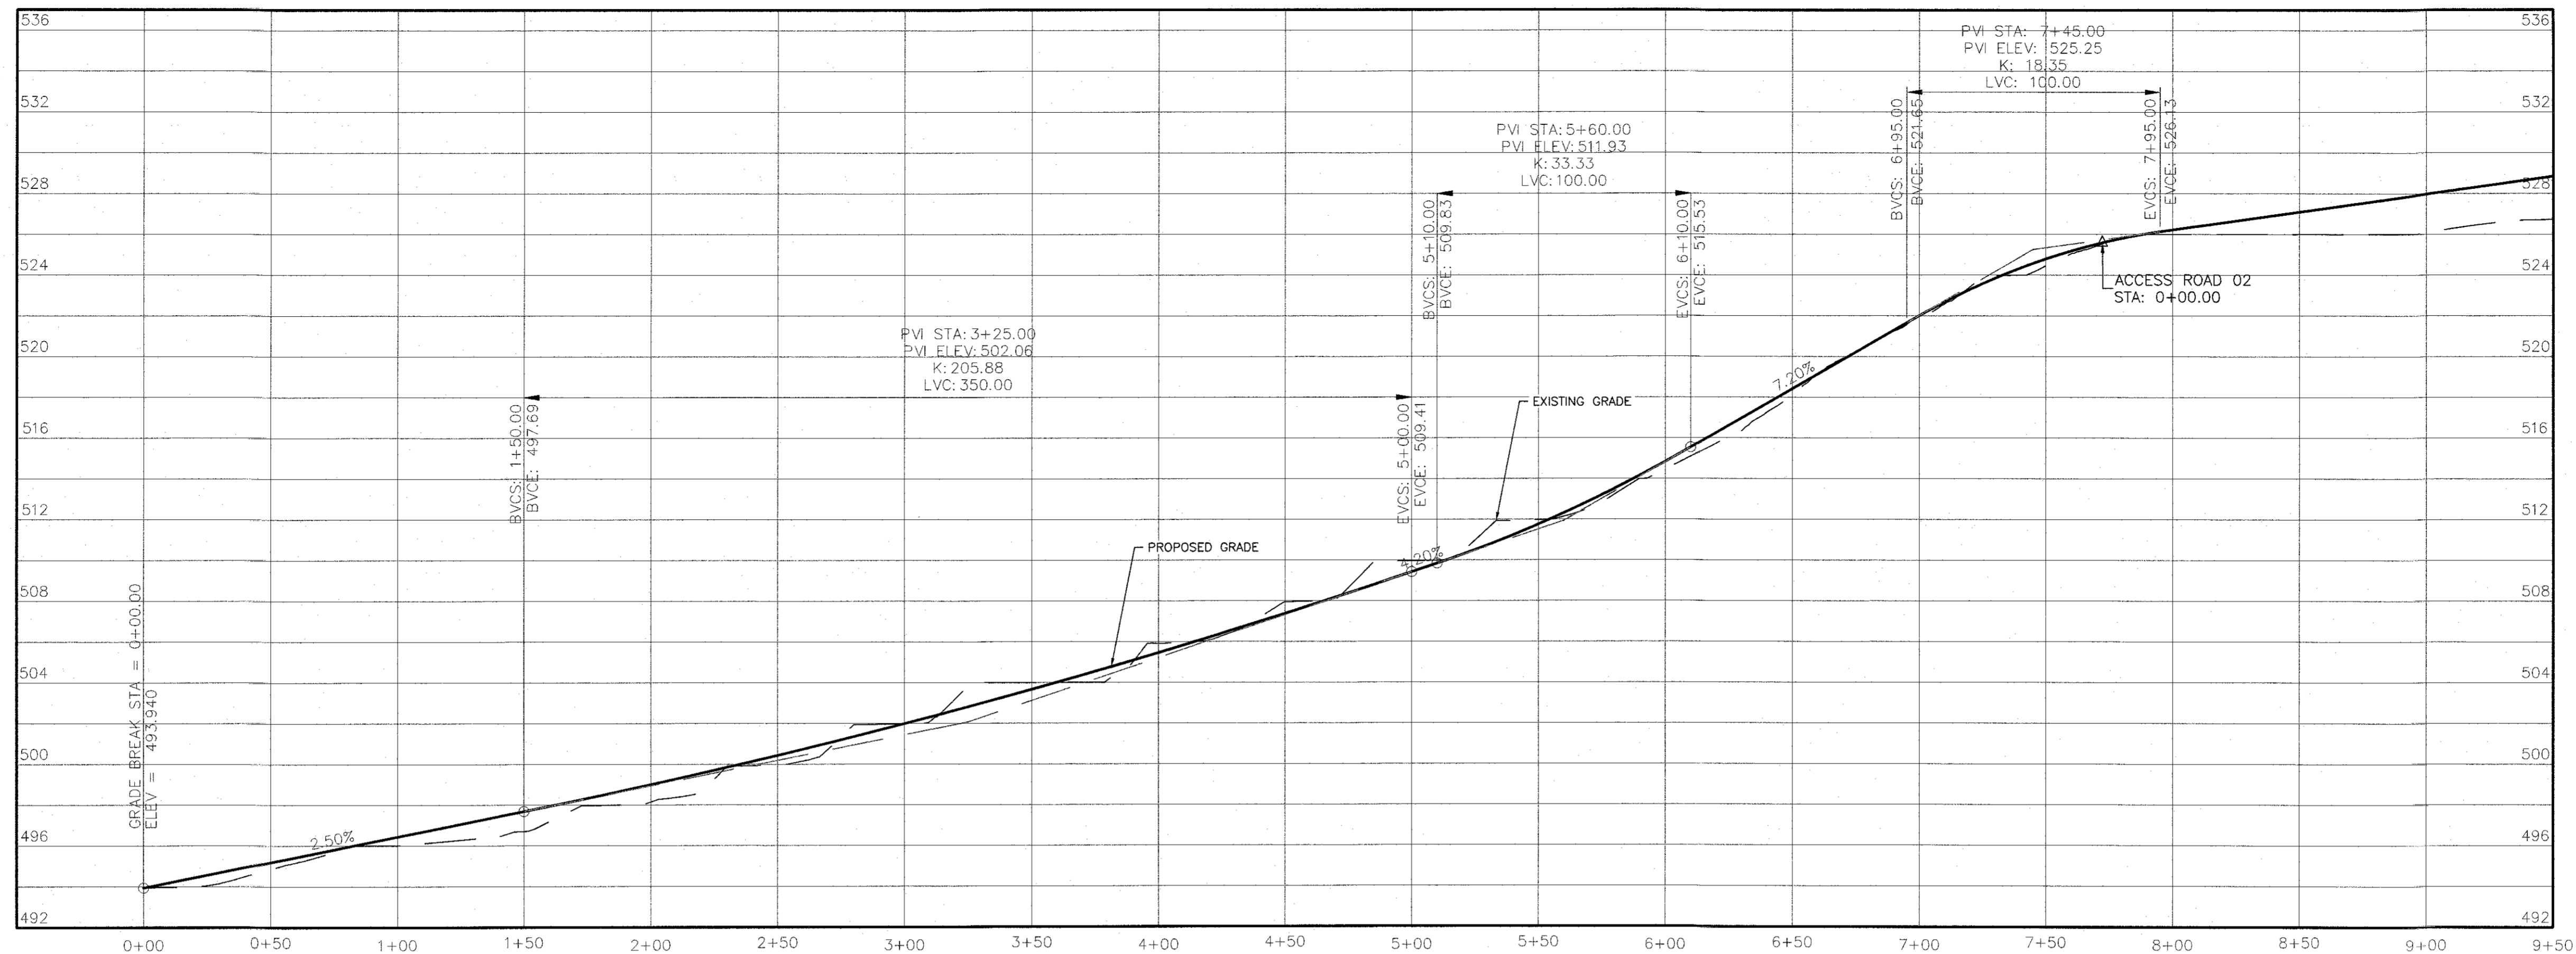

ACCESS ROAD 01 PROFILE  
 STA: 0+00 TO 9+00  
 HORIZONTAL: 1"=40'  
 VERTICAL: 1"=5'

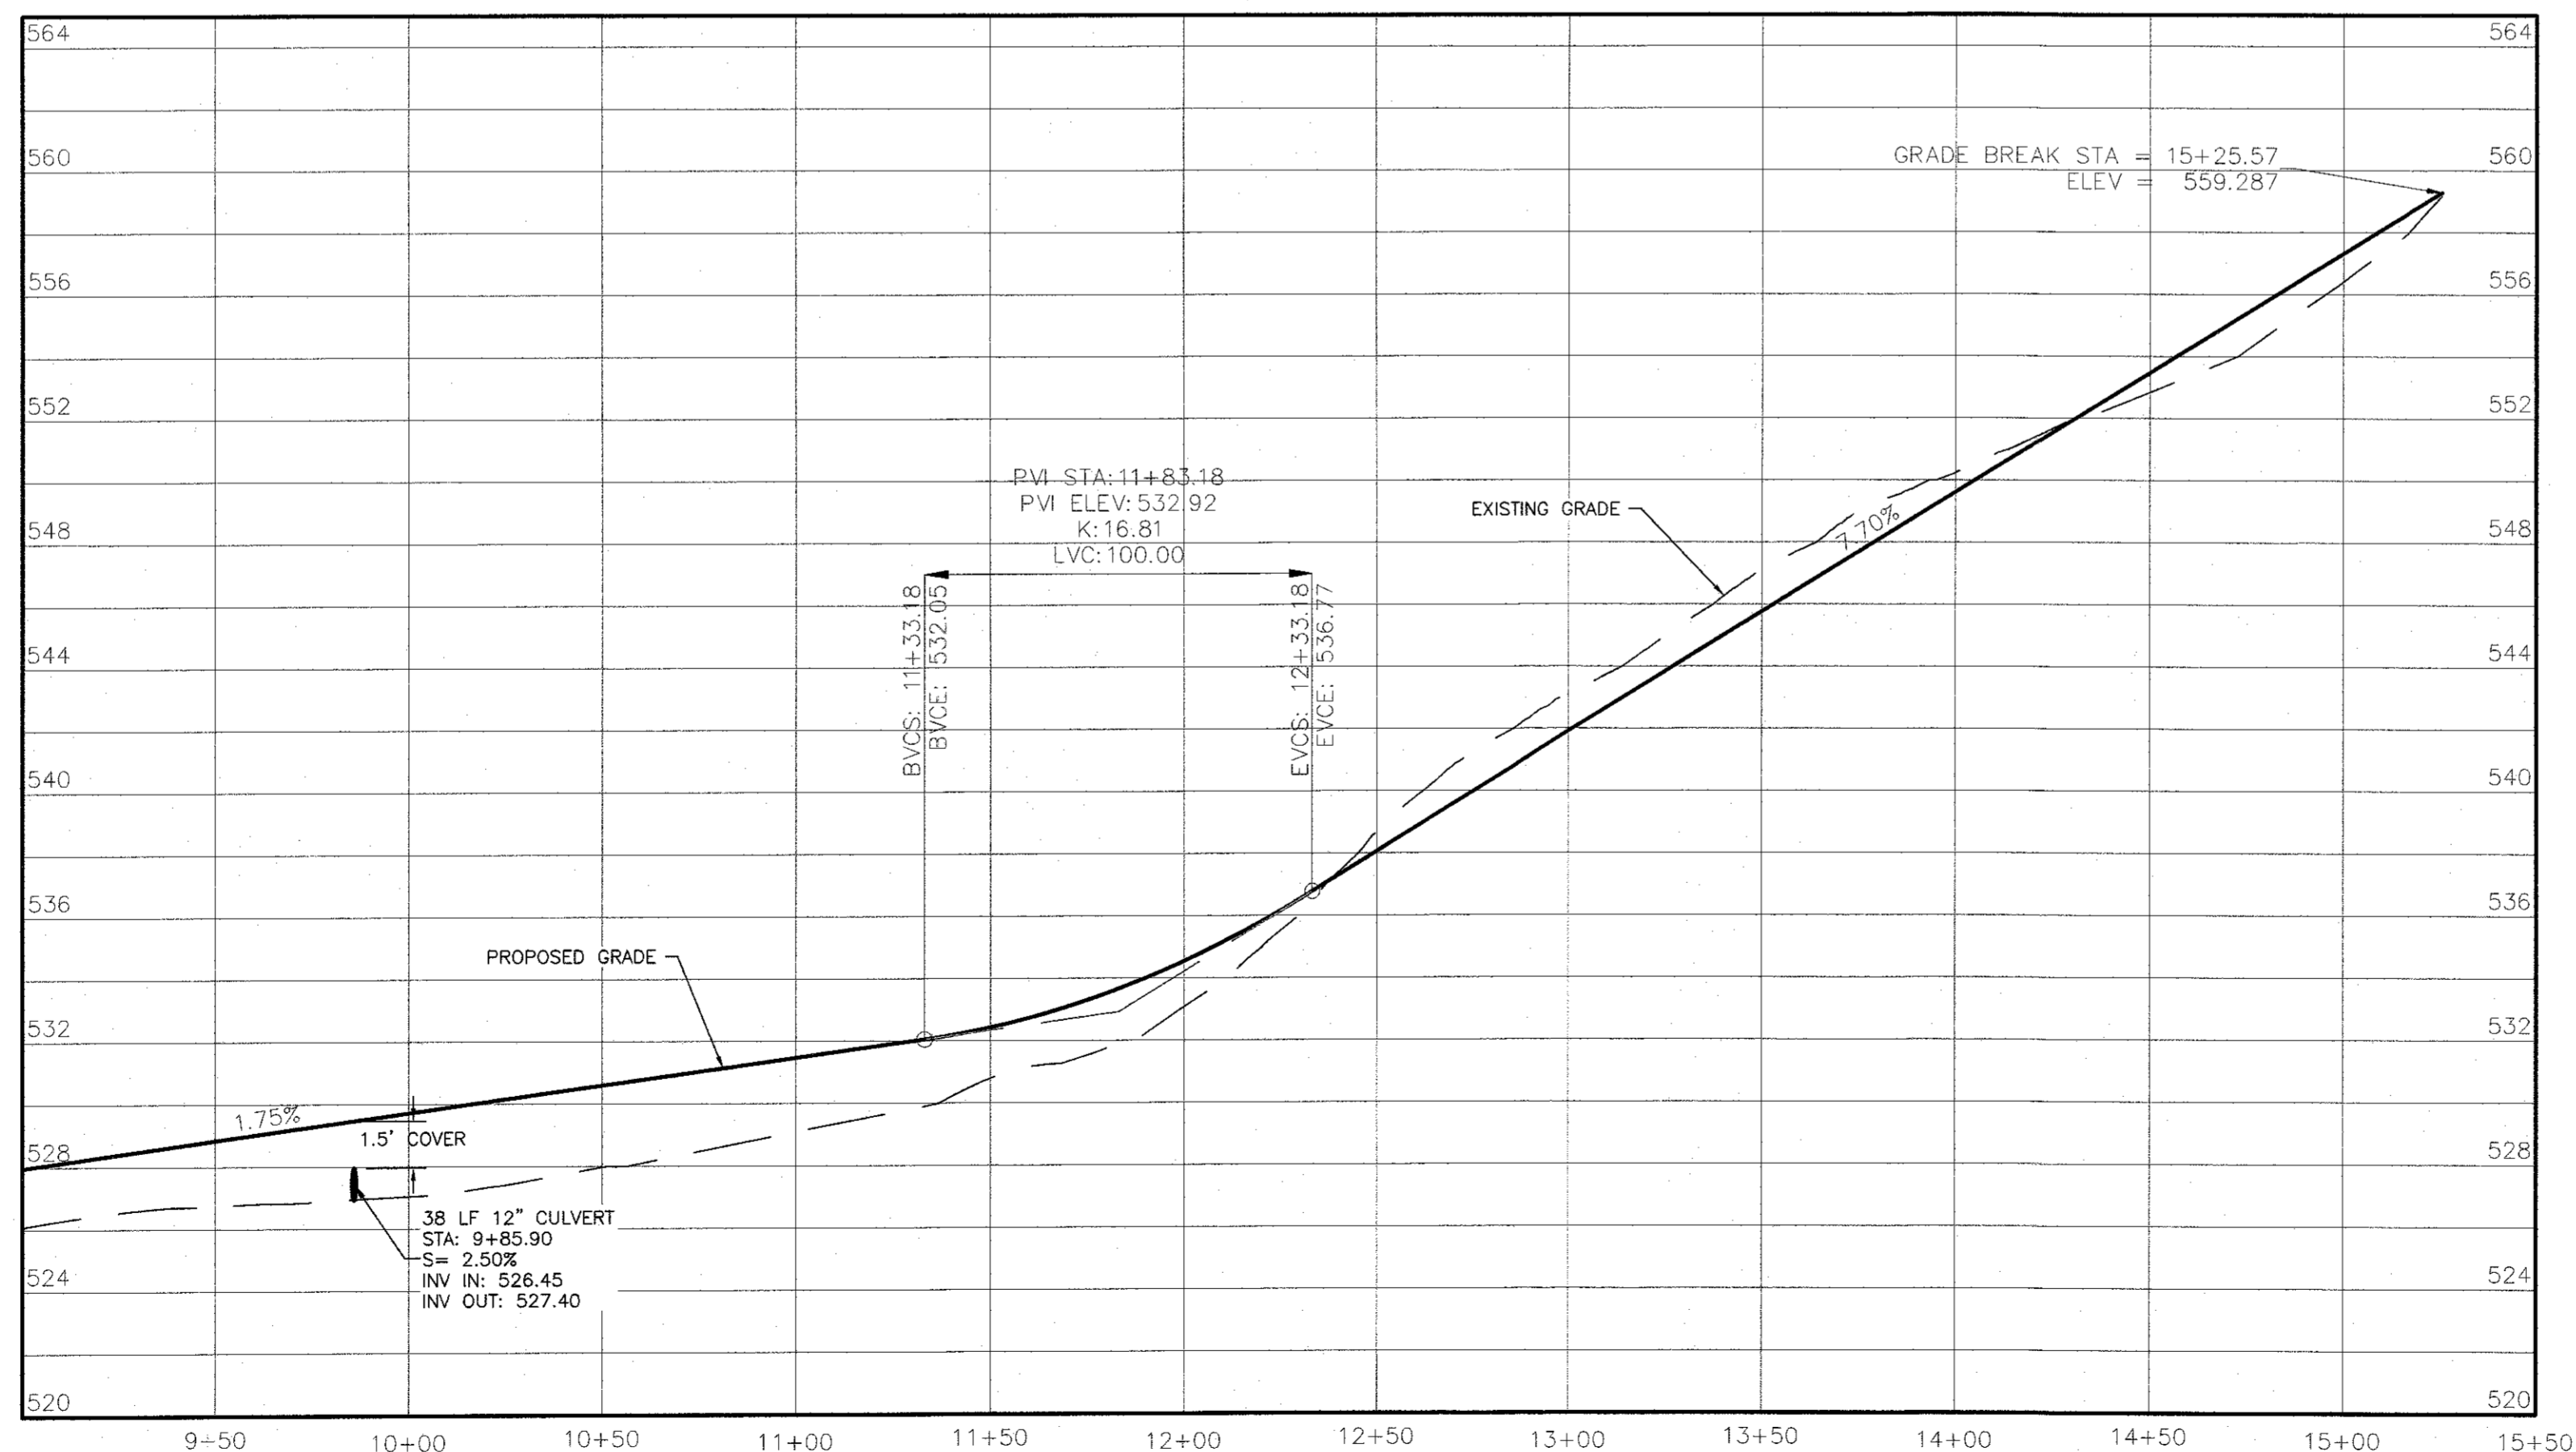

ACCESS ROAD 01 PROFILE  
 STA: 9+00 TO 15+25.57  
 HORIZONTAL: 1"=40'  
 VERTICAL: 1"=5'

#REV.	BY	DATE	DESCRIPTION
#6	MM	1/18/24	PHASING PLAN PREPARATION
#5	MM	10/12/23	DEC HW FENCE REMOVED ON PROPOSED SOLAR FARM PLANS
#4	MM	3/16/21	PER 3/16/21 SITE VISIT
#3	MM	2/23/21	PER WS COMMENTS
#2	MM	1/11/21	PER PB COMMENTS
#1	MM	10/30/20	FINAL PLAN PREPARATION

THIS SHEET IS NOT VALID WITHOUT ALL OF THE SHEETS THAT COMPRISE THE SET

**ARDEN CONSULTING ENGINEERS, PLLC**  
 P.O. BOX 340 MONROE, N.Y.  
 TEL: (845) 782-8114  
 WWW.ARDENCONSULTING.NET

AMENDED 5 MW AC SOLAR FARM SITE PLAN FOR  
**DARRIGO**  
 84 LAKESIDE AVENUE  
 TOWN OF NEWBURGH - ORANGE COUNTY, N.Y.


ACCESS ROAD PROFILES 01

JOB#: 18-014  
 SCALE: AS NOTED  
 ORIGINAL DATE: 11-12-19  
 DRAWN: MM  
 CHECKED: MM  
 SHEET NO. 06 of 09

WARNING - IT IS A VIOLATION OF NEW YORK EDUCATIONAL LAW, SECTION 7209.2, FOR ANY PERSON, UNLESS ACTING UNDER THE DIRECTION OF A LICENSED PROFESSIONAL ENGINEER OR LAND SURVEYOR, TO ALTER THIS DOCUMENT IN ANY WAY. IF ALTERED, THE ALTERING PERSON SHALL COMPLY WITH THE REQUIREMENTS OF NEW YORK EDUCATIONAL LAW, SECTION 7209.2


ONLY MAPS WITH EMBOSSED SEALS ARE GENUINE COPIES OF THE ORIGINAL WORK AND OPINION. MAPS NOT BEARING EMBOSSED SEALS SHOULD NOT BE RELIED UPON SINCE OTHER THAN EMBOSSED-SEAL COPIES MAY CONTAIN UNAUTHORIZED AND UNDETECTABLE MODIFICATIONS, DELETIONS, ADDITIONS AND CHANGES.



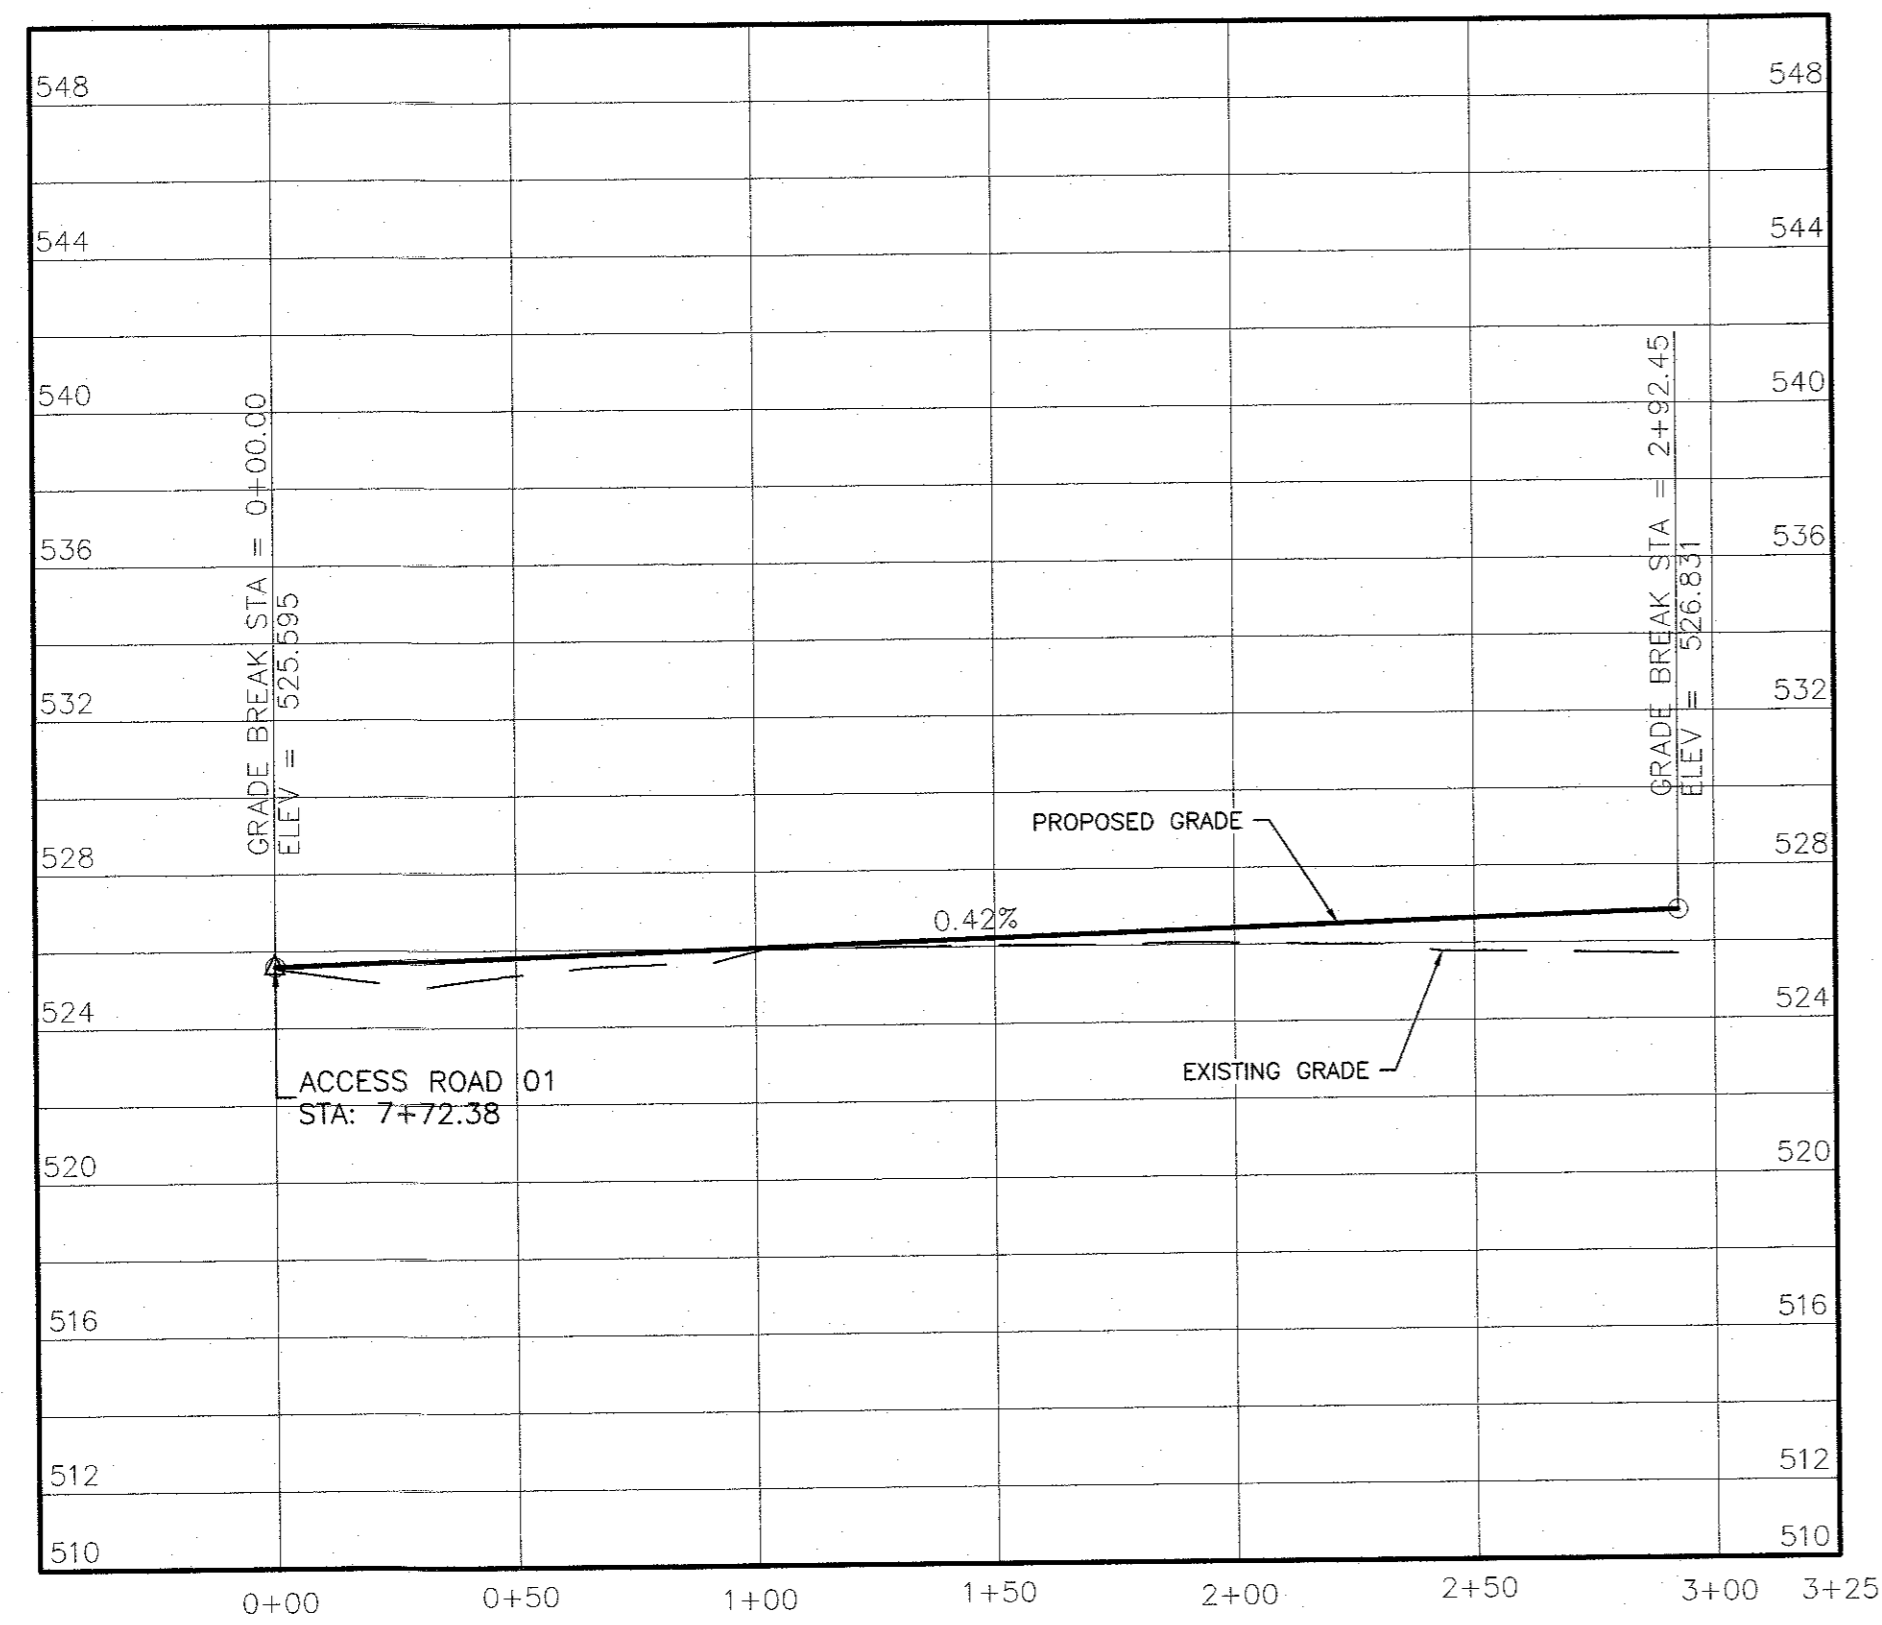


ACCESS ROAD 02 PROFILE

HORIZONTAL: 1"=40'  
VERTICAL: 1"=5'

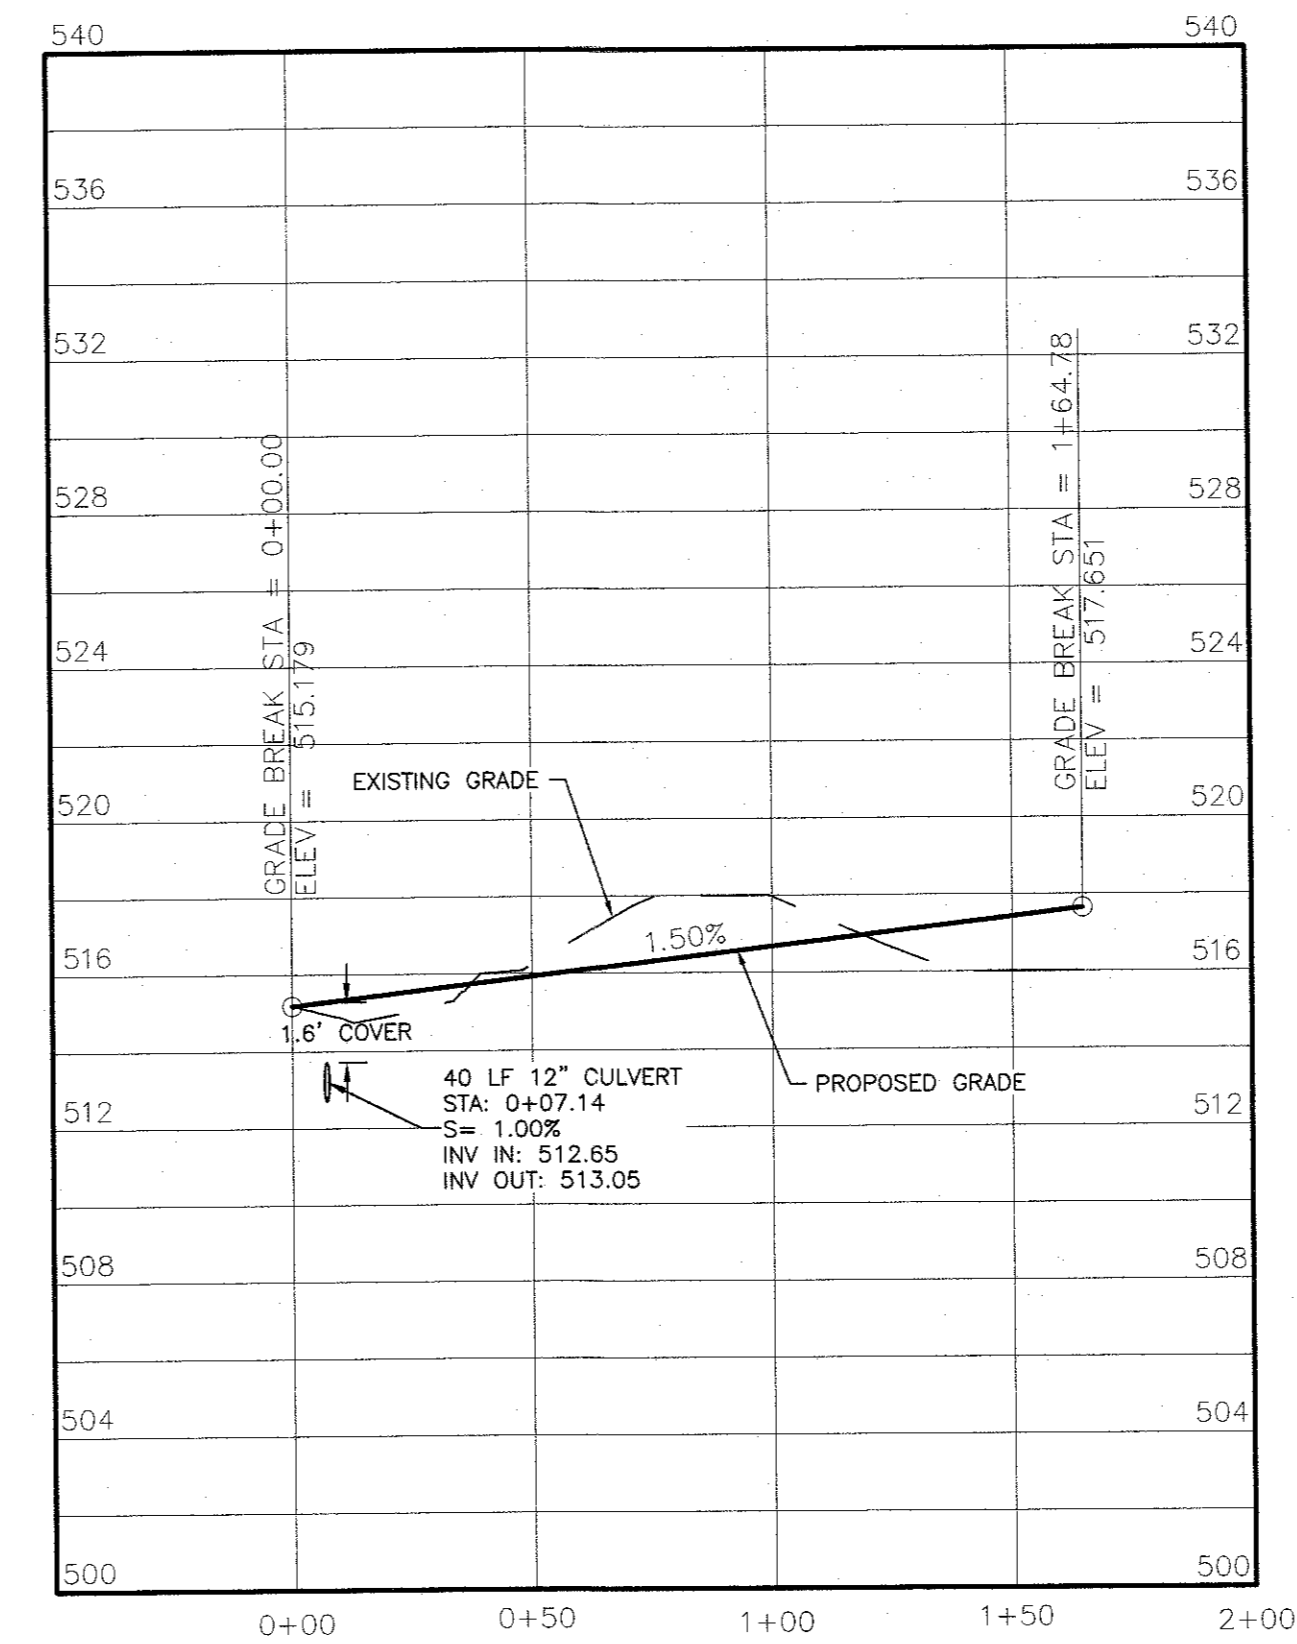

ACCESS ROAD 03 PROFILE

HORIZONTAL: 1"=40'  
VERTICAL: 1"=5'

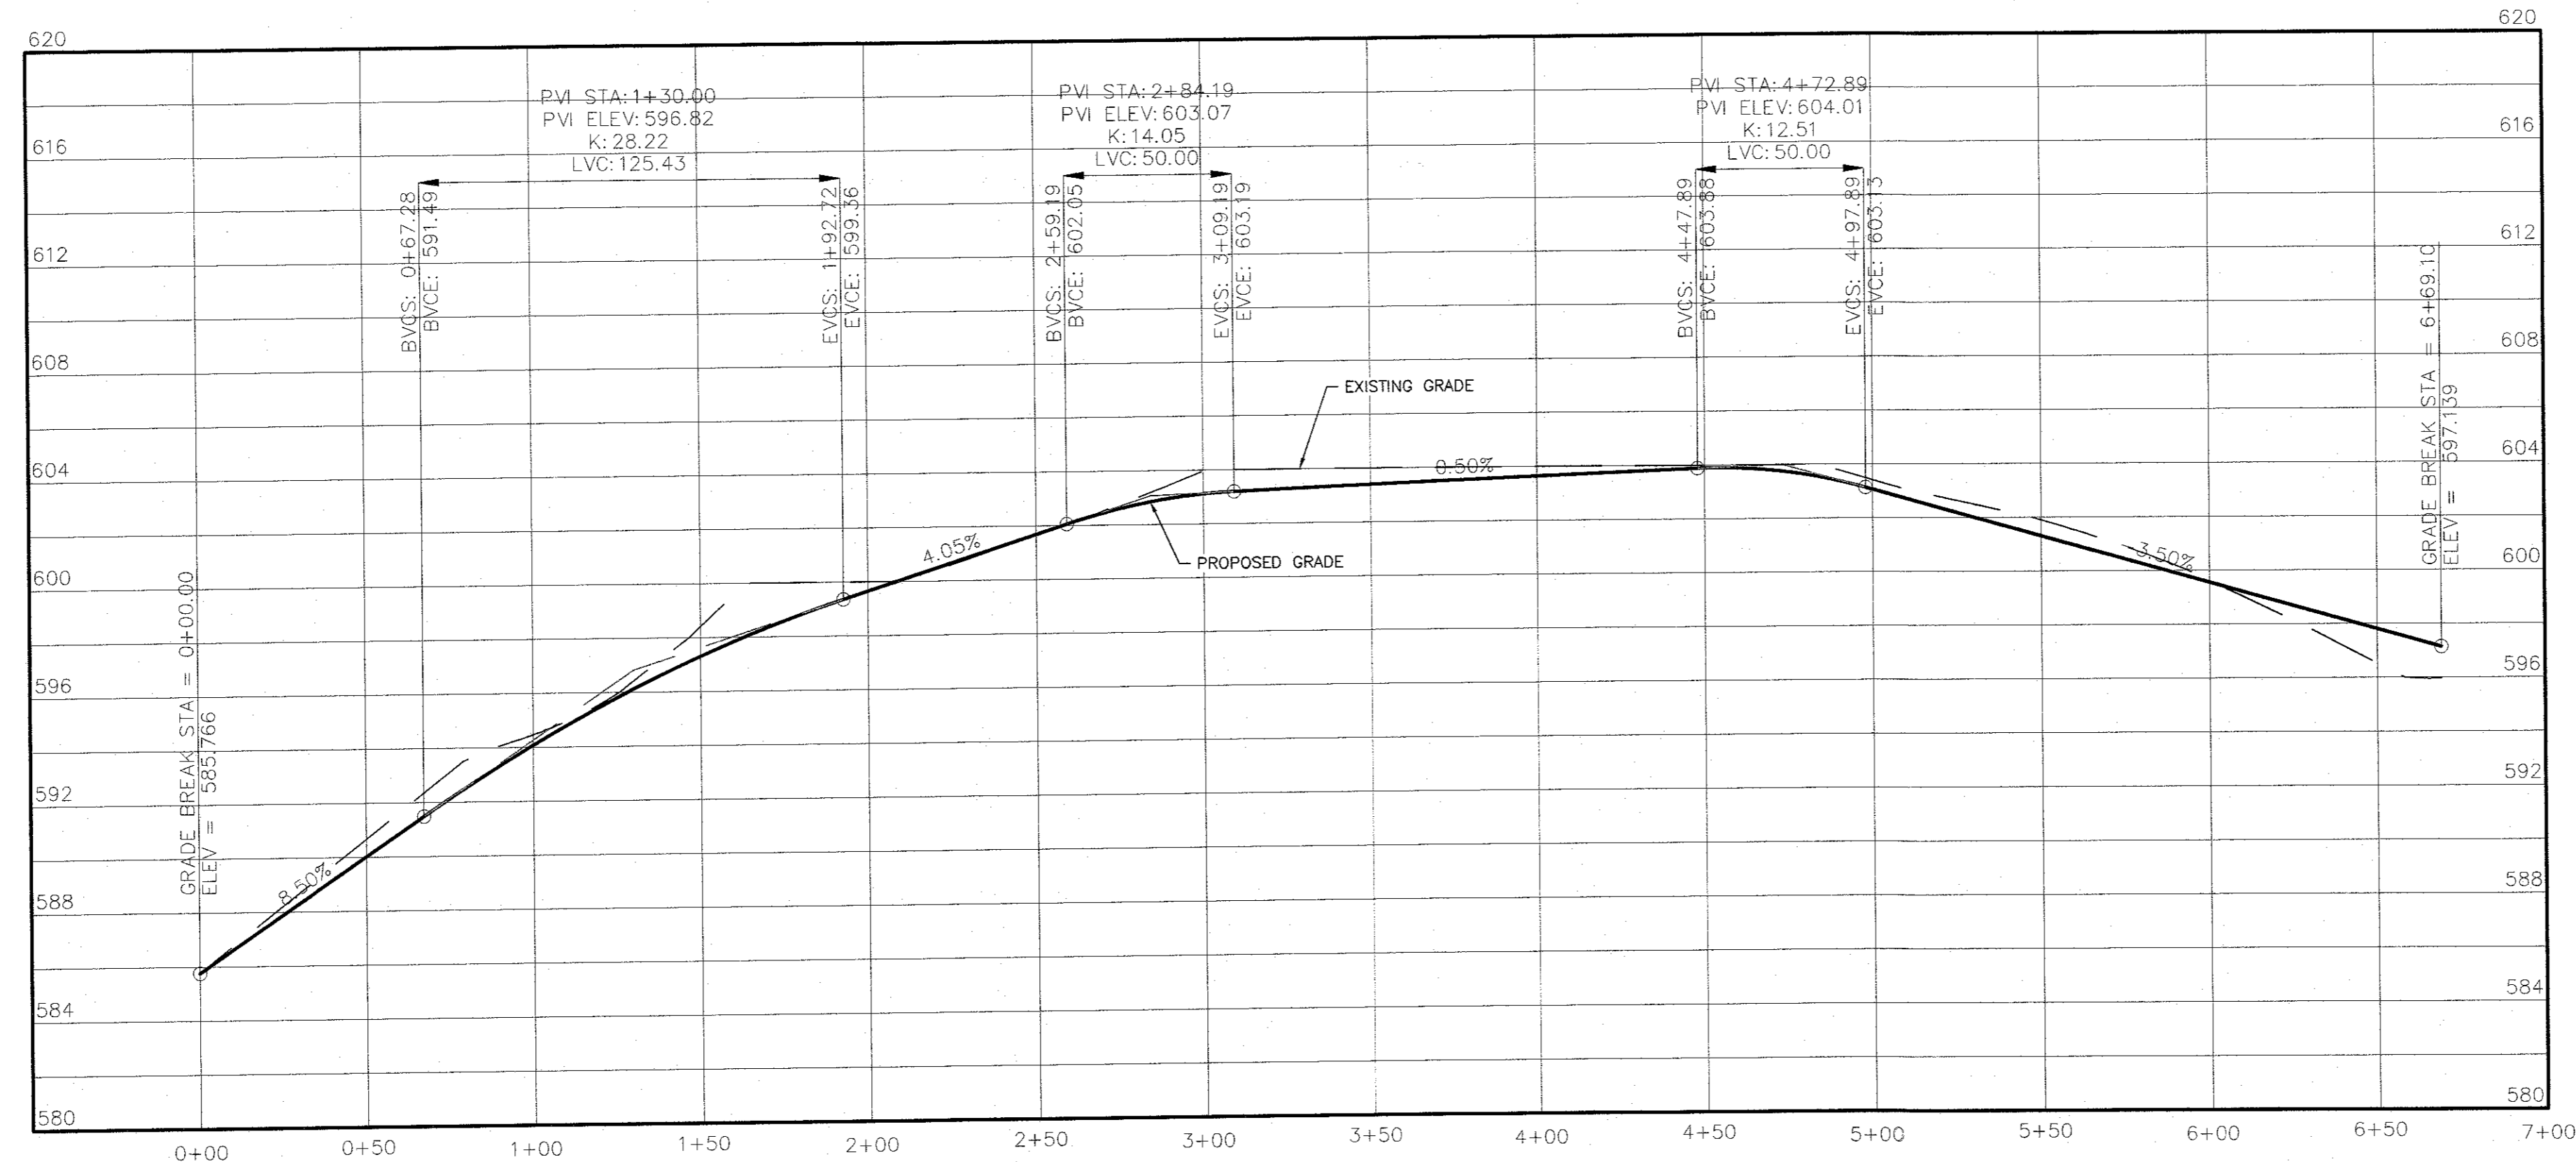


ACCESS ROAD 04 PROFILE

HORIZONTAL: 1"=40'  
VERTICAL: 1"=5'

#REV.	BY	DATE	DESCRIPTION
#6	MM	1/18/24	PHASING PLAN PREPARATION
#5	MM	10/12/23	DEC HW FENCE REMOVED ON PROPOSED SOLAR FARM PLANS
#4	MM	3/16/21	PER 3/16/21 SITE VISIT
#3	MM	2/23/21	PER WS COMMENTS
#2	MM	1/11/21	PER PB COMMENTS
#1	MM	10/30/20	FINAL PLAN PREPARATION

THIS SHEET IS NOT VALID WITHOUT ALL OF THE SHEETS THAT COMPRISE THE SET

ARDEN CONSULTING ENGINEERS, PLLC  
P.O. BOX 340 MONROE, N.Y.  
TEL: (845) 782-8114  
WWW.ARDENCONSULTING.NET

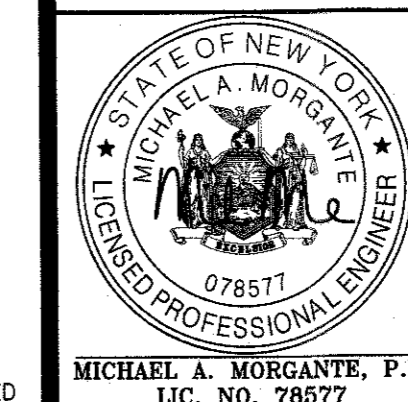


AMENDED 5 MW AC SOLAR FARM SITE PLAN FOR  
DARRIGO  
84 LAKESIDE AVENUE  
TOWN OF NEWBURGH - ORANGE COUNTY, N.Y.




ACCESS ROAD PROFILES 02

JOB#: 18-014  
SCALE: AS NOTED  
ORIGINAL DATE: 11-12-19  
DRAWN: MM  
CHECKED: MM  
SHEET NO. 07 of 09

WARNING- IT IS A VIOLATION OF NEW YORK EDUCATIONAL LAW, SECTION 7209.2, FOR ANY PERSON, UNLESS ACTING UNDER THE DIRECTION OF A LICENSED PROFESSIONAL ENGINEER OR LAND SURVEYOR, TO ALTER THIS DOCUMENT IN ANY WAY. IF ALTERED, THE ALTERING PERSON SHALL COMPLY WITH THE REQUIREMENTS OF NEW YORK EDUCATIONAL LAW, SECTION 7209.2

ONLY MAPS WITH EMBOSSED SEALS ARE GENUINE COPIES OF THE ORIGINAL WORK AND OPINION. MAPS NOT BEARING EMBOSSED SEALS SHOULD NOT BE RELIED UPON SINCE OTHER THAN EMBOSSED-SEAL COPIES MAY CONTAIN UNAUTHORIZED AND UNDETECTABLE MODIFICATIONS, DELETIONS, ADDITIONS AND CHANGES.

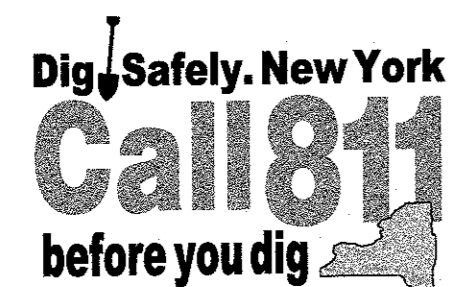

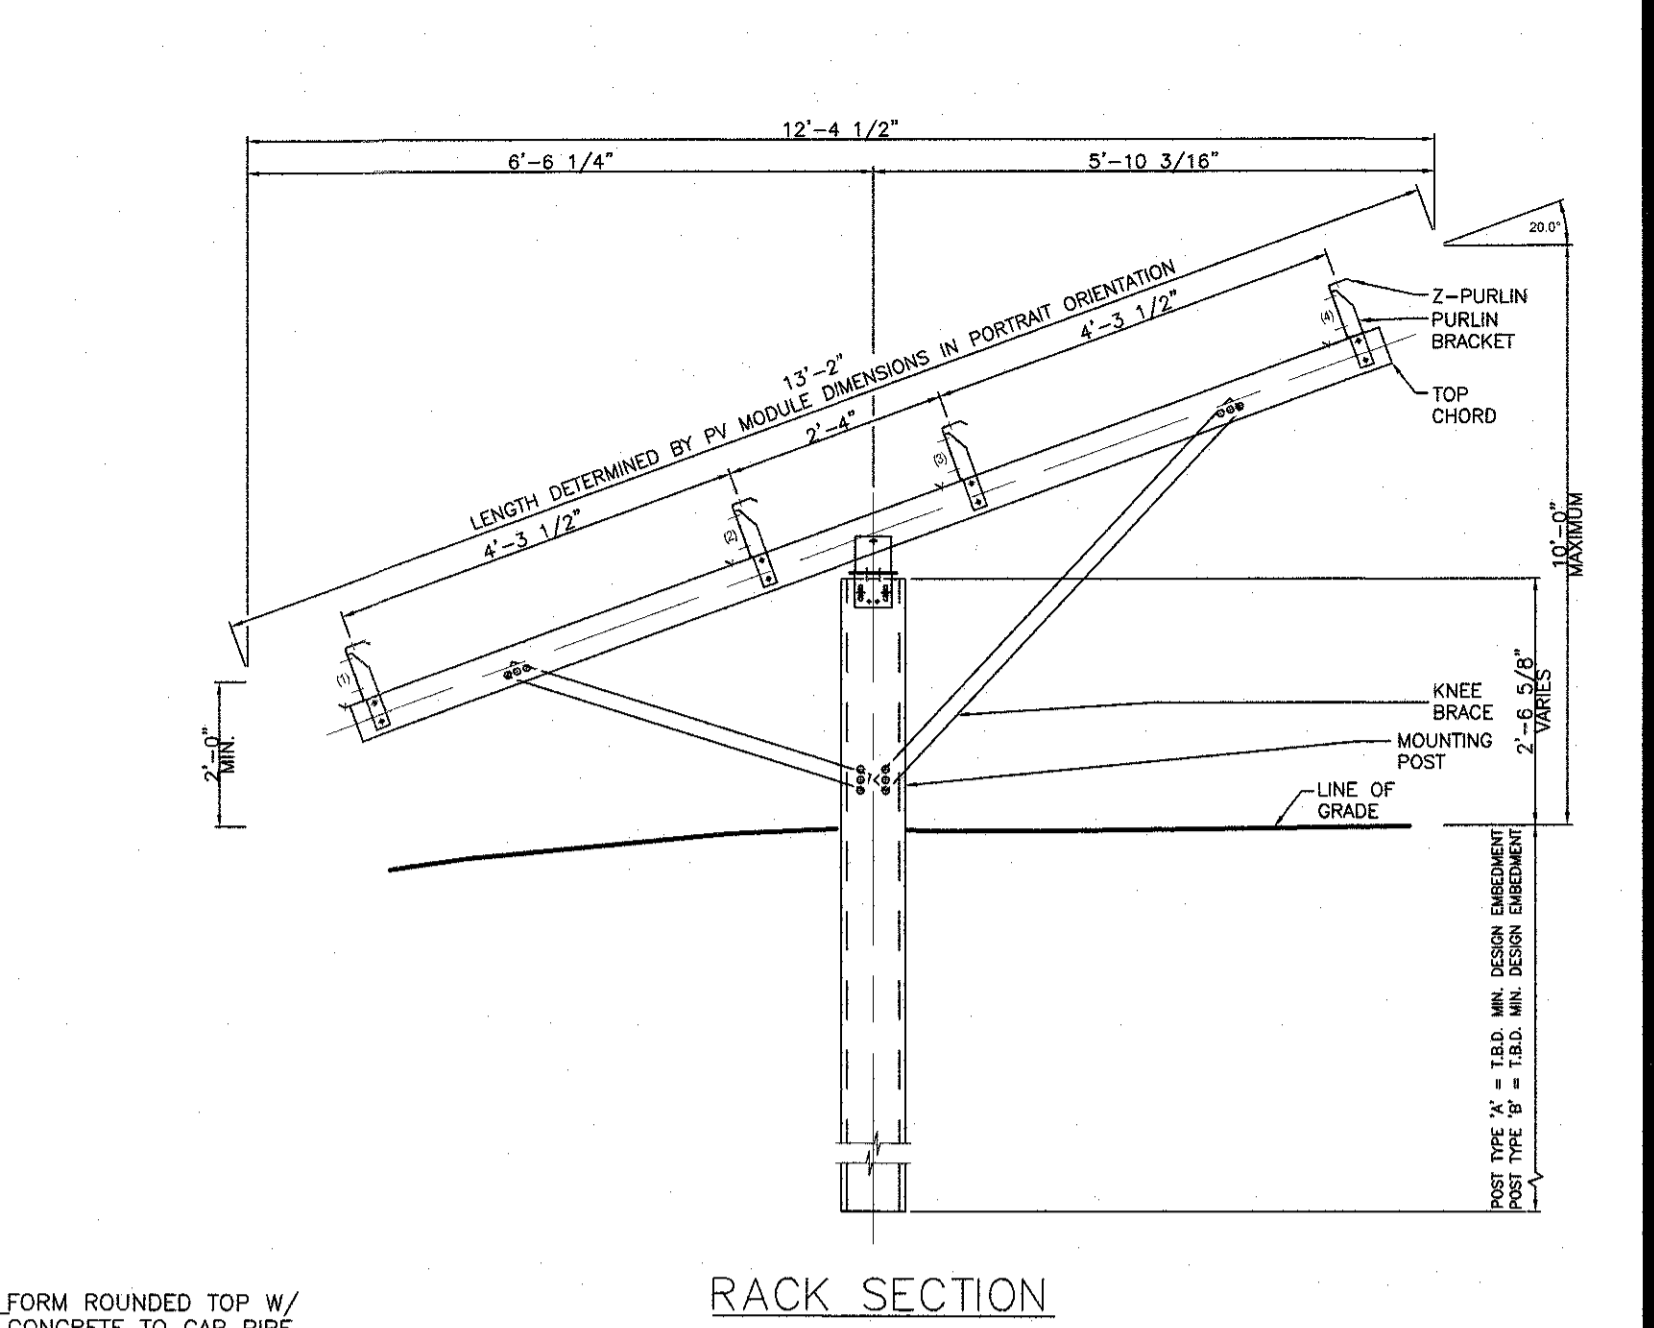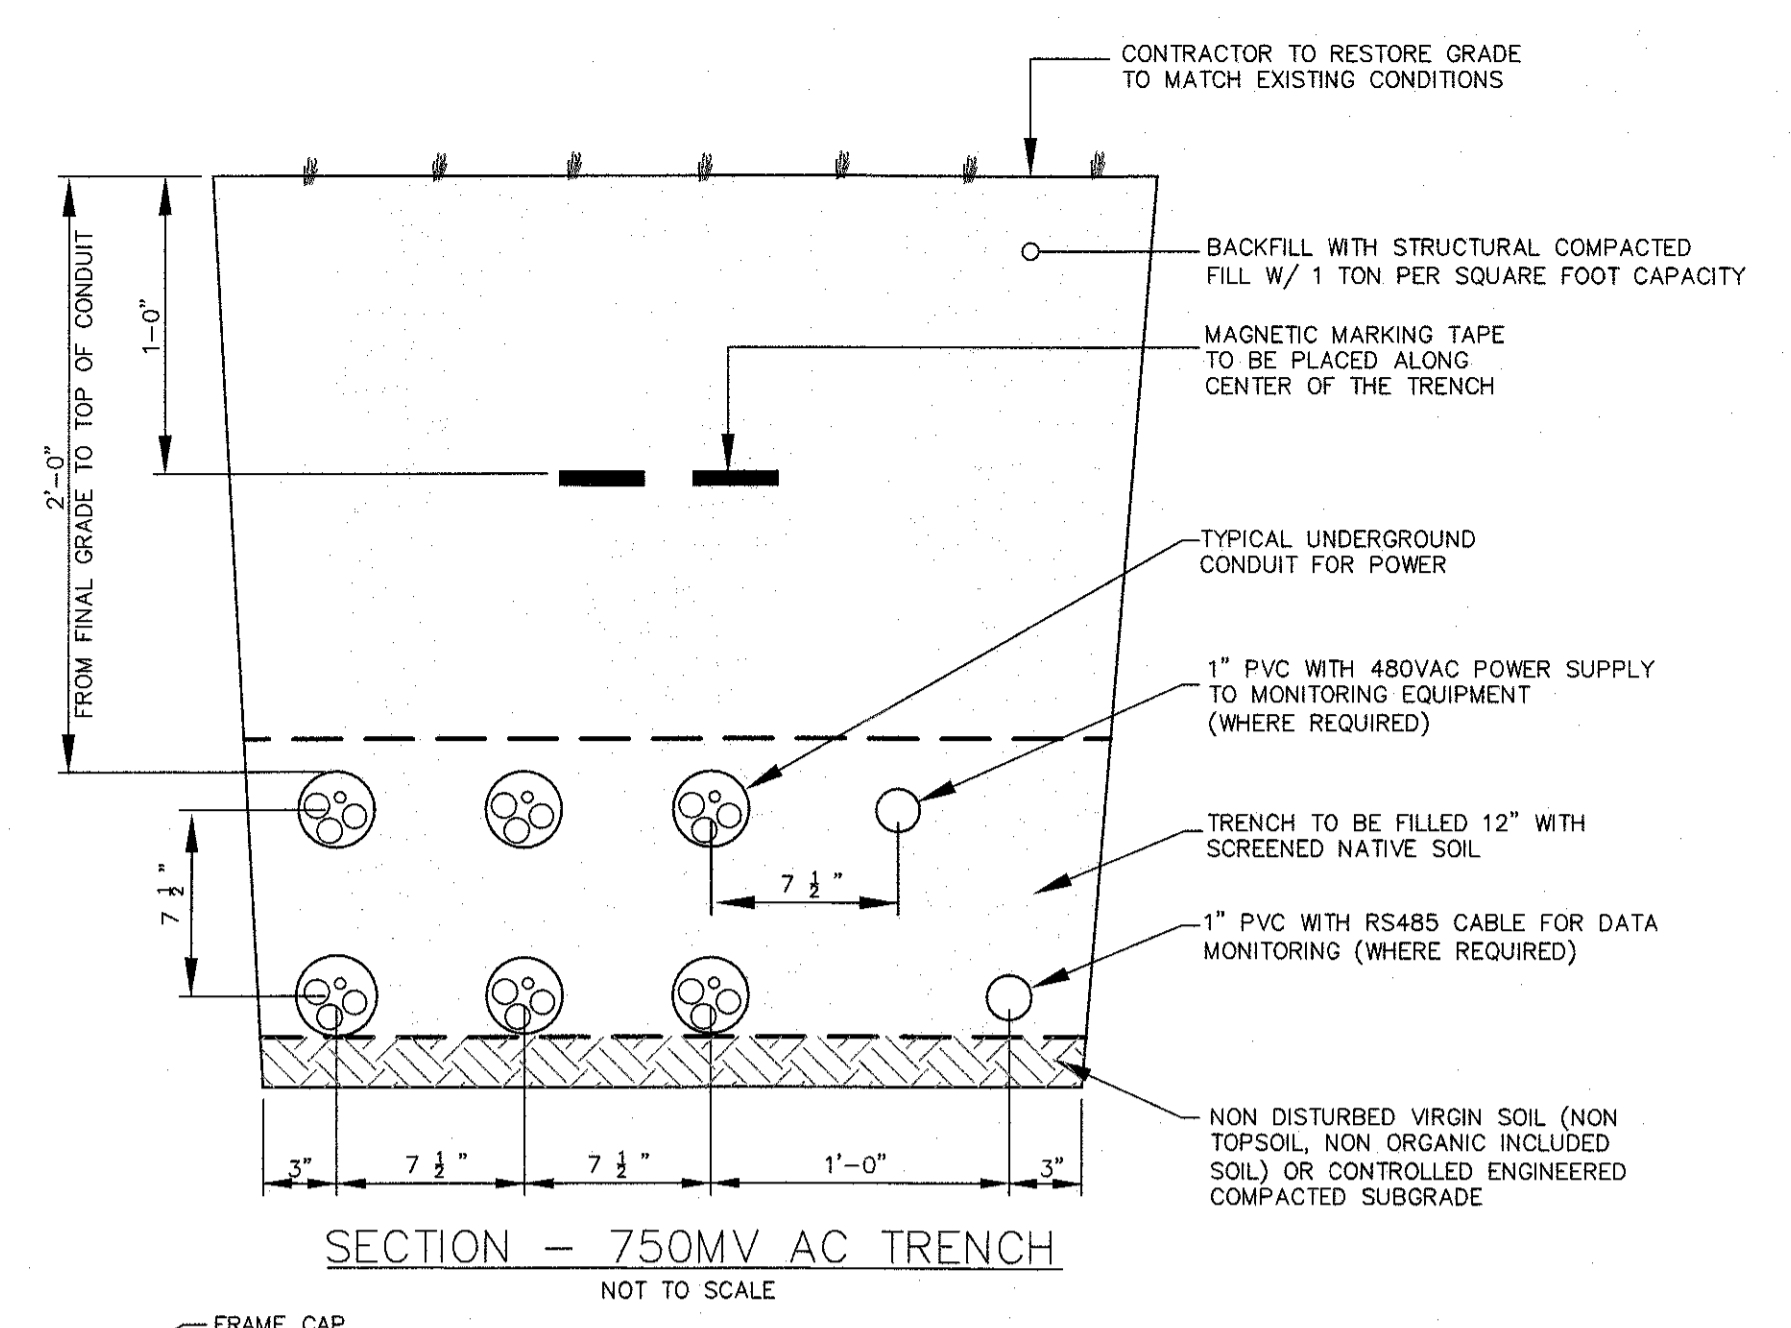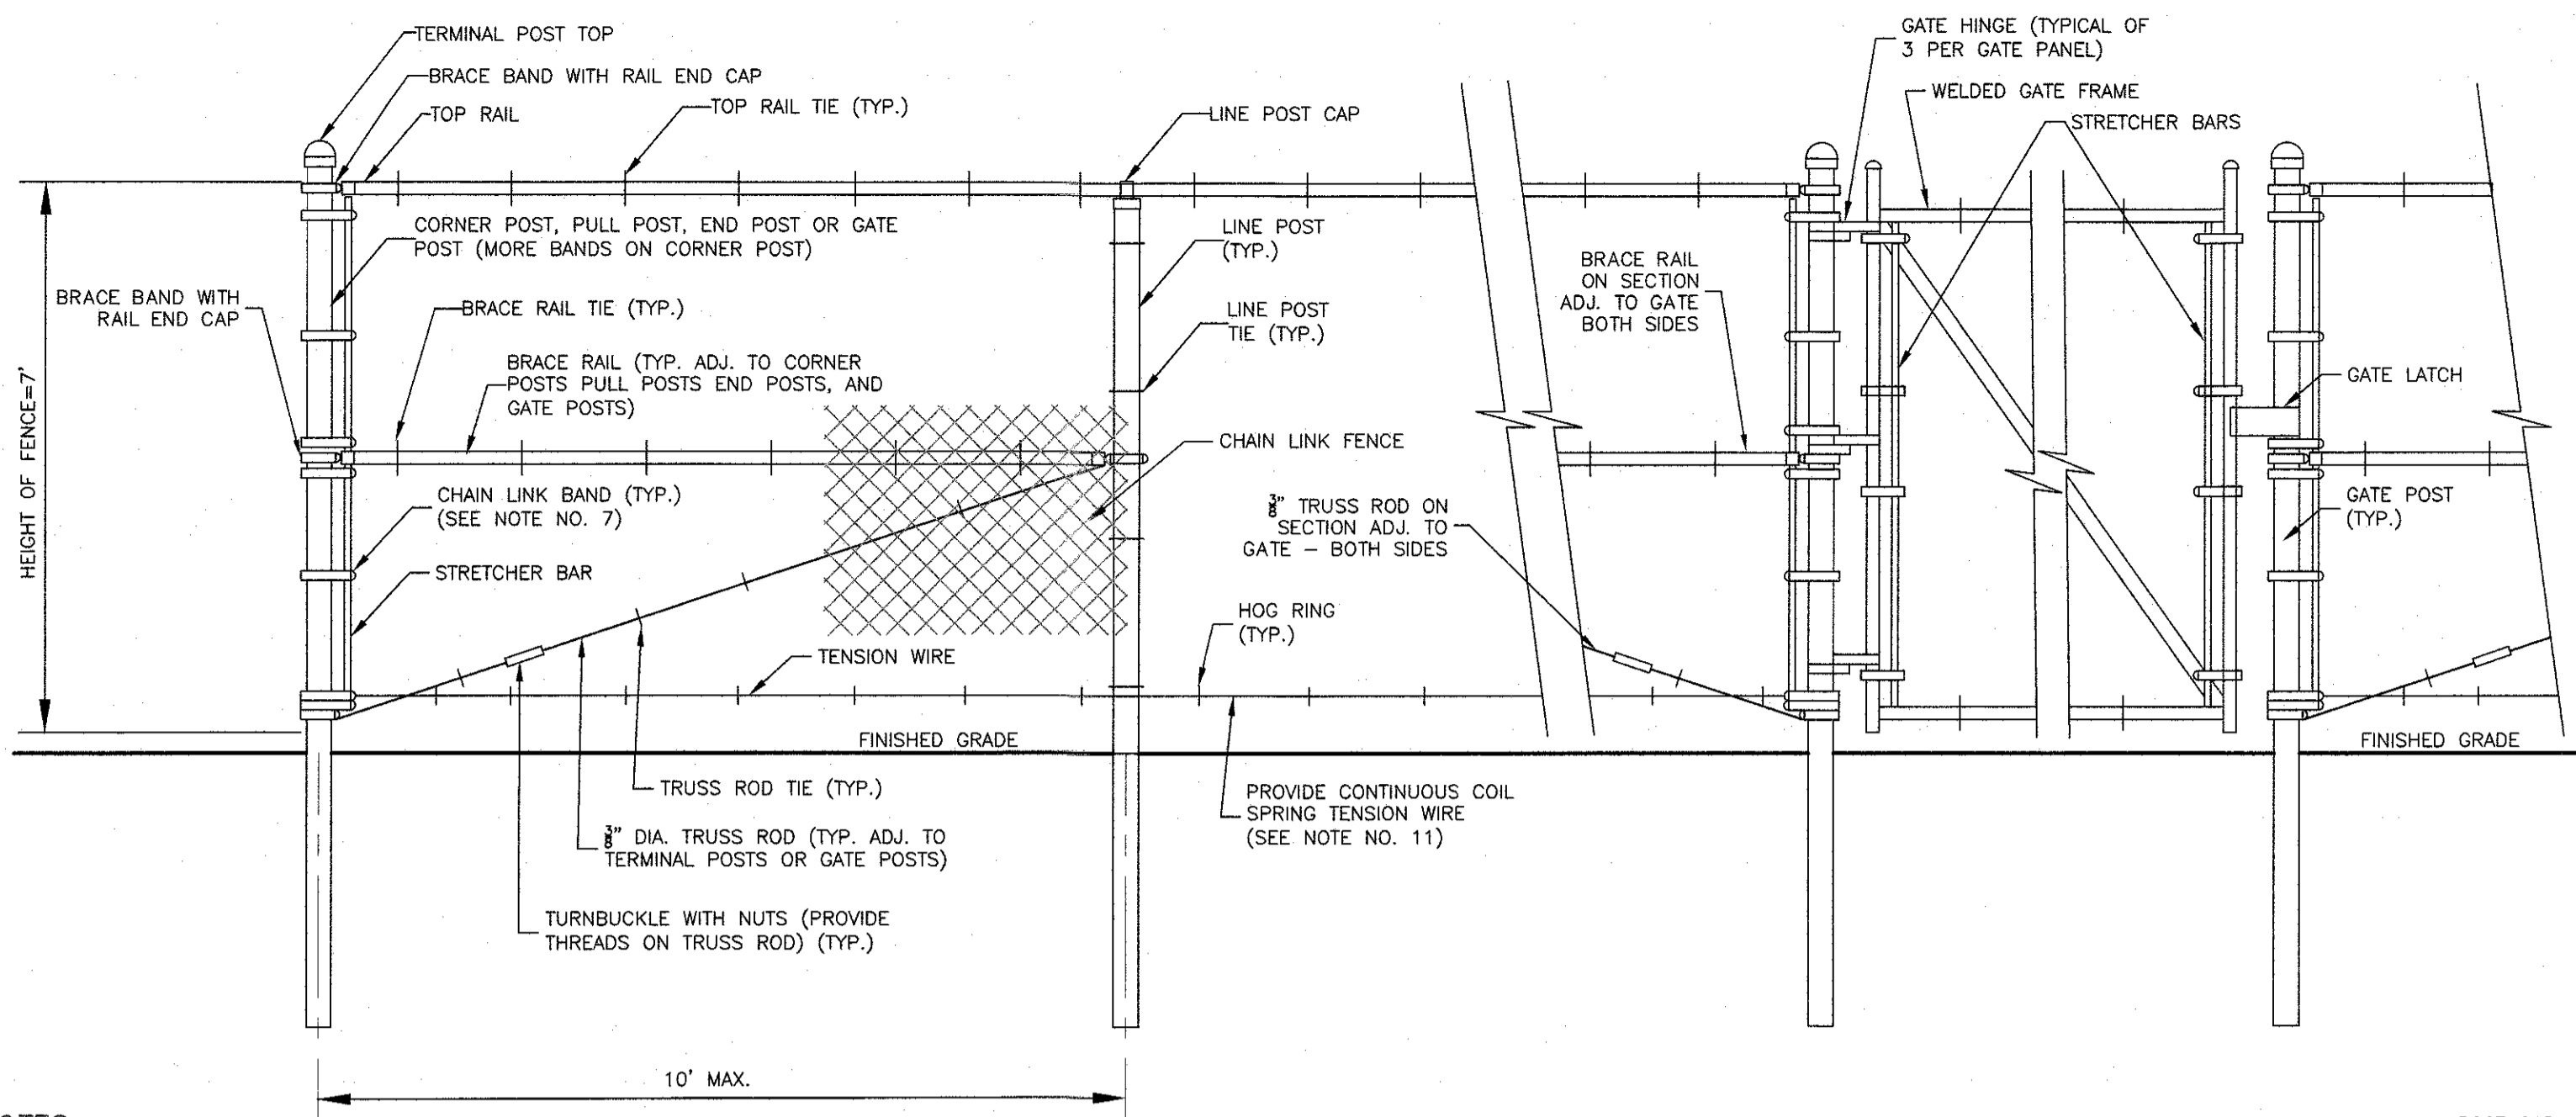

**NOTES:**


- STEEL POSTS RAILS & BRACES SHALL BE STANDARD WEIGHT SCHEDULE 40 GALVANIZED STEEL PIPE. POSTS, RAILS, AND BRACES SHALL BE STANDARD HEIGHT SCHEDULE 40 GALVANIZED STEEL PIPE, MANUFACTURED IN ACCORDANCE WITH ASTM F1083. PIPE SHALL BE GALVANIZED BOTH INSIDE AND OUT IN ACCORDANCE WITH ASTM F1083.
  - PIPE/TUBING DIAMETERS INDICATED HEREIN ARE FENCE INDUSTRY O.D. (OUTSIDE DIAMETER). THE FOLLOWING TABLE ALSO PRESENTS ACTUAL DECIMAL O.D. EQUIVALENTS.
- | FENCE INDUSTRY O.D. | DECIMAL O.D. EQUIVALENT |
|---------------------|-------------------------|
| 1 3/8"              | 1.315"                  |
| 1 5/8"              | 1.660"                  |
| 2"                  | 1.900"                  |
| 2 1/2"              | 2.375"                  |
| 3"                  | 2.875"                  |
| 3 1/2"              | 3.500"                  |
| 4"                  | 4.000"                  |
| 4 1/2"              | 4.500"                  |
| 6 5/8"              | 6.625"                  |
| 8 5/8"              | 8.625"                  |
- CORNER POSTS, PULL POSTS, AND END POSTS SHALL BE 3" O.D. FOR 7' HIGH FENCE.
  - FOR SMALL GATES, SINGLE PANEL GATE OPENING WIDTH OF 4'-0" OR LESS AND DOUBLE PANEL GATE OPENING WIDTH OF 8'-0" OR LESS, GATE POSTS SHALL BE 3" O.D. FOR 7' HIGH FENCE. FOR LARGER GATES, SINGLE PANEL GATE OPENING WIDTH OF UP TO 8'-0" AND DOUBLE PANEL GATE OPENING WIDTHS OF UP TO 16'-0", GATE POSTS SHALL BE 3" O.D. FOR 7' HIGH FENCE. OTHER GATE POSTS SHALL BE AS NOTED OR DETAILED IN THE DRAWINGS.
  - LINE POSTS SHALL BE 2 1/2" O.D. FOR 7' HIGH FENCE.
  - TOP RAIL & BRACE SHALL BE 1 3/8" O.D.
  - FENCE FABRIC SHALL BE SECURED TO CORNER POSTS, PULL POSTS, AND GATE OR END POSTS WITH STRETCHER BARS (TENSION RODS) FABRICATED FROM GALVANIZED STEEL AND SECURED TO THE SAID POSTS BY THE FOLLOWING NUMBER OF EQUALLY SPACED CHAIN LINK BANDS WITH AN INSIDE DIAMETER APPROPRIATE TO THE OUTSIDE DIAMETER OF THE POST TO WHICH THEY ATTACH:
    - FOR 7' HIGH FENCE: 7 EACH CHAIN LINK BANDS PER FENCE DIRECTION.
  - DOUBLE GATE PANEL GATES SHALL BE PROVIDED WITH HOLD OPEN DEVICES.
  - DOUBLE PANEL GATES SHALL BE PROVIDED WITH A CENTER DROP ROD AND A DROP ROD CATCHMENT PIPE SET IN CONCRETE AND LOCATED SUCH THAT WHEN THE DROP IS ENGAGED, THE GATE PANELS ARE ON THE SAME HORIZONTAL ALIGNMENT AS THE ADJACENT FENCE.

**NOTES:**

- THE GATE LATCH SHALL BE THE MALLEABLE IRON FORK TYPE AS MANUFACTURED BY "HOOPER FENCE CO." AS THEIR "STRONG ARM" INDUSTRIAL GATE LATCH. PAD LOCKS WILL BE PROVIDED BY THE OWNER.
- GATE HINGES SHALL BE WELDABLE STEEL, CAST STEEL, OR MALLEABLE IRON 180 DEGREE OFFSET INDUSTRIAL TYPE. THE HINGES SHALL NOT TWIST OR TURN UNDER THE ACTION OF THE GATE. THE GATE(S) SHALL BE CAPABLE OF BEING CLOSED BY ONE PERSON. HINGES SHALL BE GALVANIZED.
- POST FOUNDATIONS:
  - CORNER POSTS, PULL POSTS, END POSTS, AND GATE POSTS SHALL EACH BE SET IN CONCRETE FOUNDATIONS AS FOLLOWS:

POST SIZE (FENCE INDUSTRY O.D.)	DIAMETER	DEPTH
2 1/2" O.D.	12"	3'-6"
3" O.D.	12"	3'-6"
3 1/2" O.D.	15"	3'-6"
4" O.D.	18"	3'-6"
4 1/2" O.D.	18"	4'-0"


LARGER POSTS AND SPECIFIC CONDITIONS SHALL BE AS DETAILED. DETAILS SHALL TAKE PRECEDENCE OVER THESE NOTES IF AT VARIANCE.

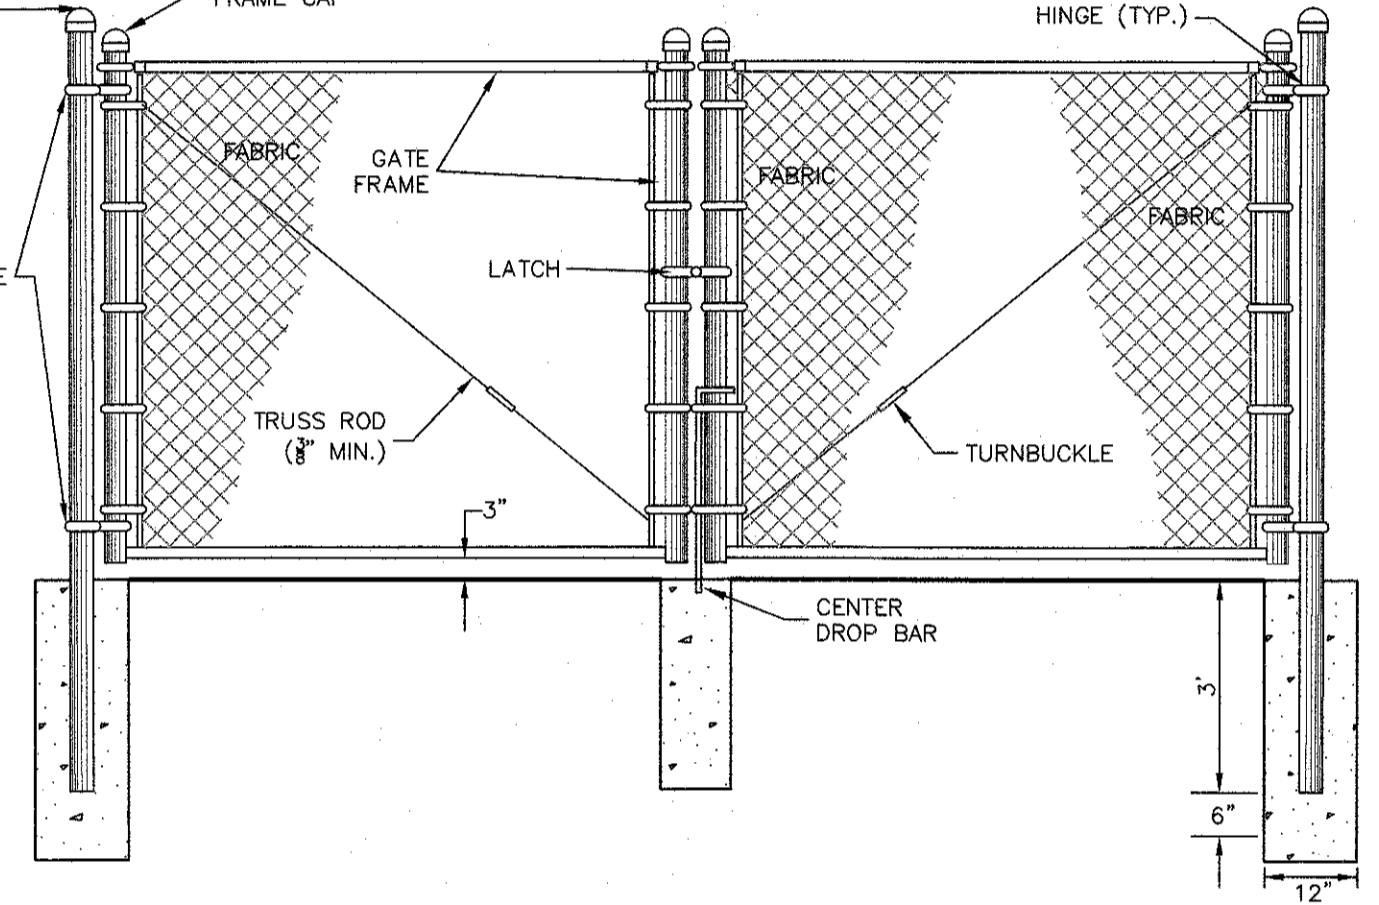

**NOTE:** PERIMETER GATES SECURED FOR RESTRICTED ACCESS MUST BE EQUIPPED WITH AN EMERGENCY SERVICES ENTRY SYSTEM PROVIDE KNOX EXTERIOR PADLOCK MODEL 3770. THE PADLOCK SHALL BE DAISY CHAINED WITH THE OWNER PADLOCK(S) PROVIDED.

**CHAIN LINK SECURITY FENCE DETAIL DOUBLE PANEL GATE**

NOT TO SCALE

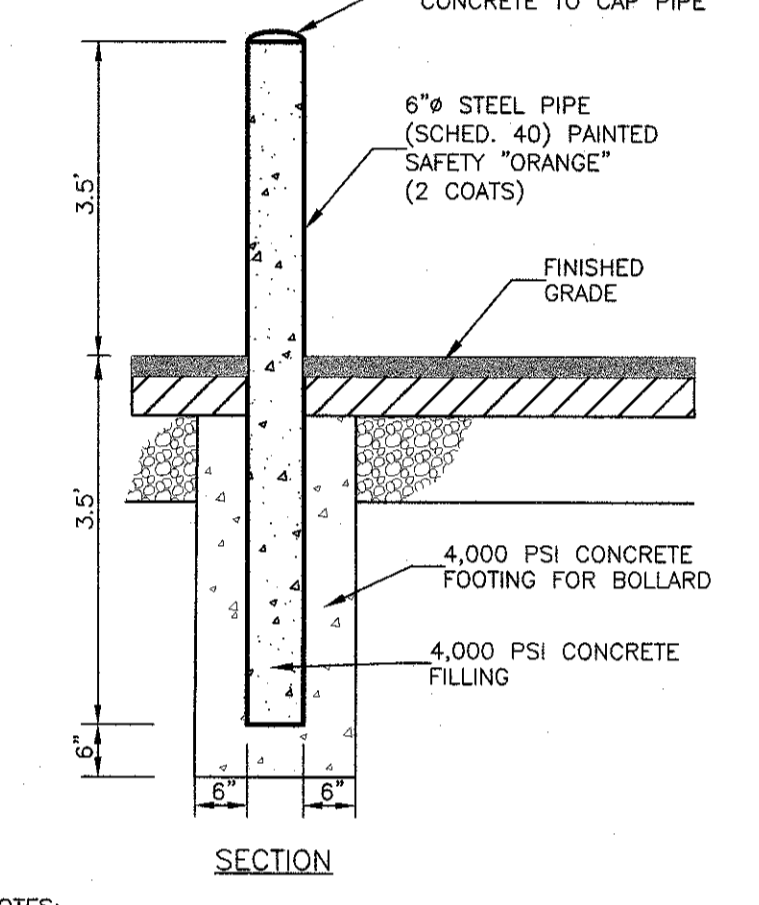


**NOTES:**

- HORIZONTAL DISTANCE FROM CENTERLINE TO CENTERLINE OF BOLLARDS SHALL BE 4'-0" MAXIMUM.
- HORIZONTAL DISTANCE FROM BOLLARD TO OBJECT BEING PROTECTED SHALL BE 3'-6" MINIMUM.
- SEE PLANS FOR BOLLARD LOCATIONS.

**STEEL & CONCRETE BOLLARD DETAIL**


NOT TO SCALE

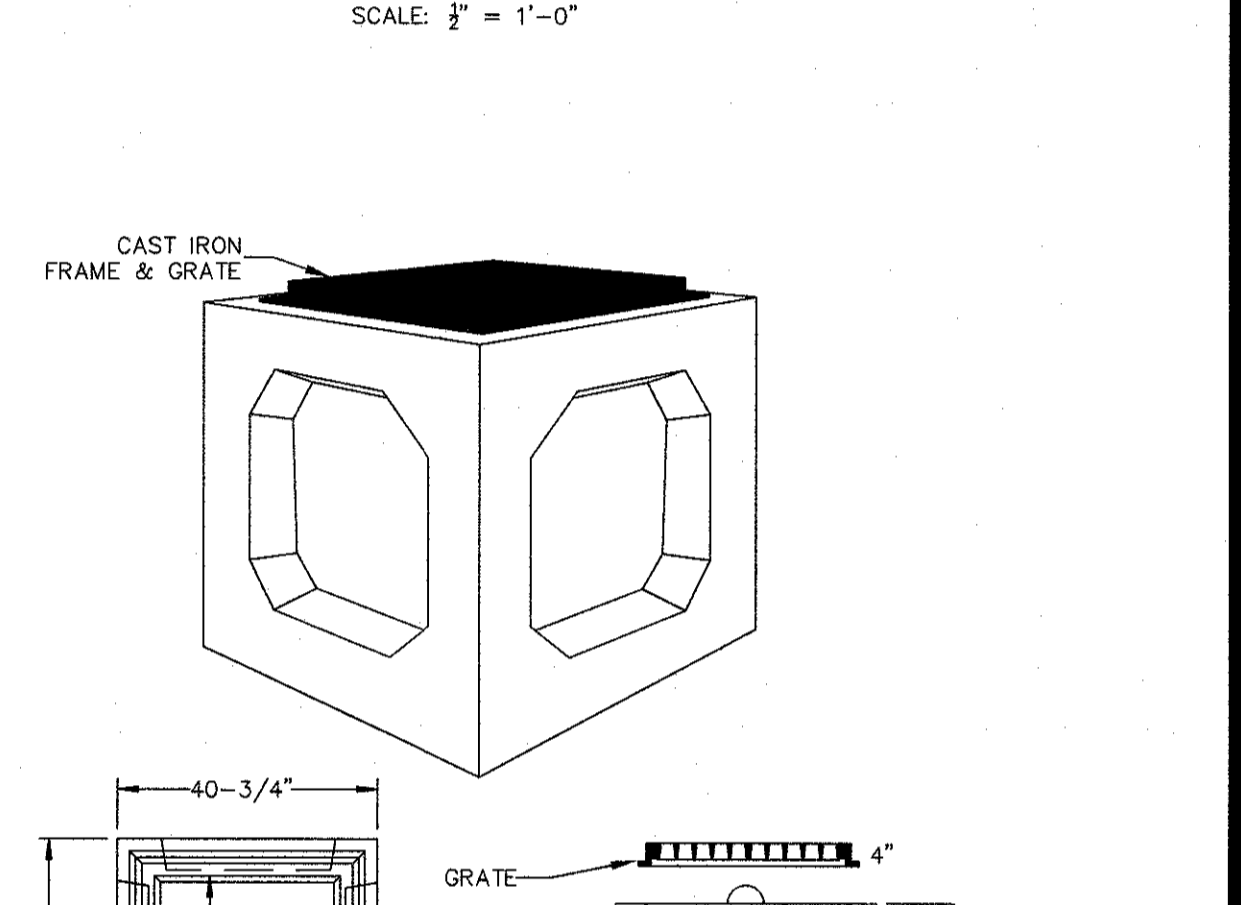

**CONCRETE MIN. STRENGTH:** 4,000 PSI AT 28 DAYS  
**REINFORCEMENT:** #4 REBAR / ASTM A615  
**AIR ENTRAINMENT:** 5%  
**CONSTRUCTION JOINT:** BUTYL RUBBER SEALANT  
**WEIGHTS:** BASE = 2,200 LBS, RISER = 950 LBS/FOOT  
**LOAD RATING:** H20 / ASTM C857

**PRECAST 30\"/>**

NOT TO SCALE

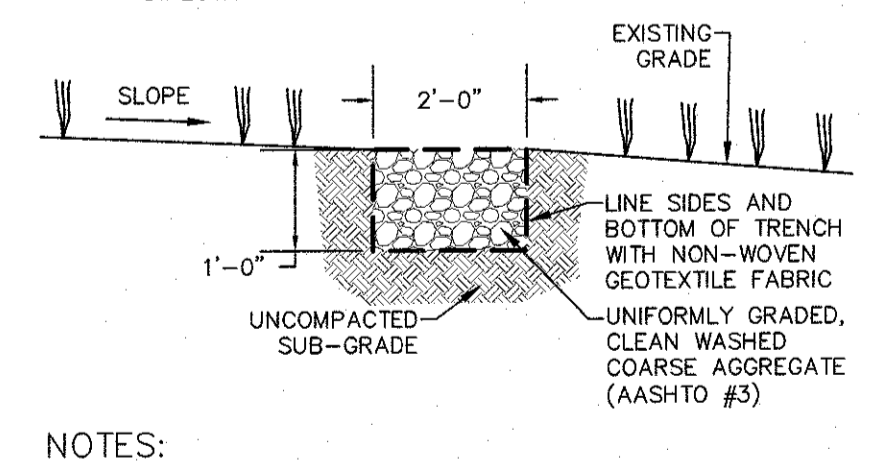


**NOTES:**


- INSTALL ON EXISTING AREAS THAT HAVE A 10% SLOPE OR LESS.

**LEVEL SPREADER DETAIL**


NOT TO SCALE

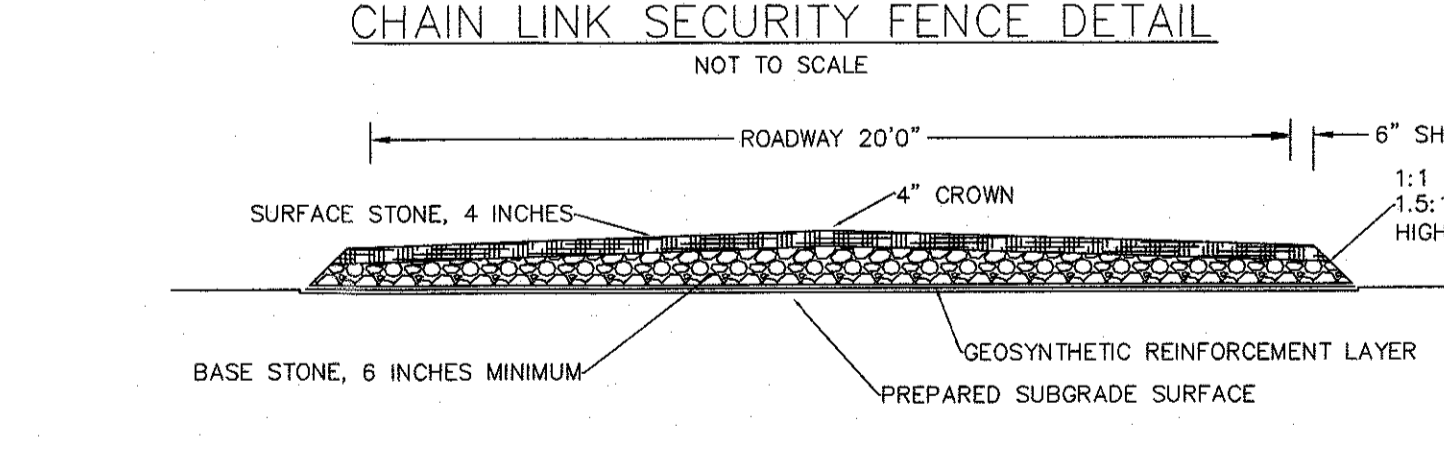


1 B512 1/2" = 1 FOOT

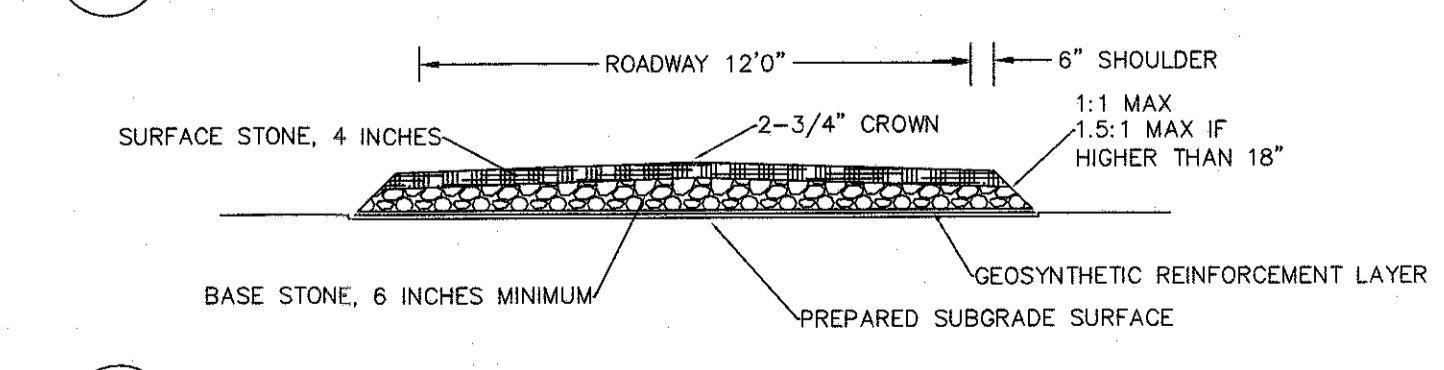


2 B512 1/2" = 1 FOOT

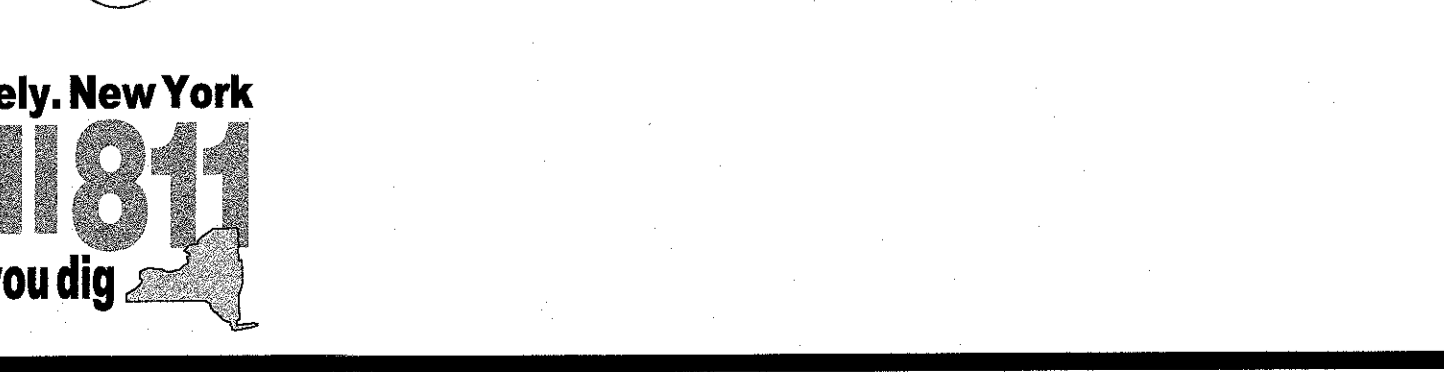


1A B512 1/2" = 1 FOOT

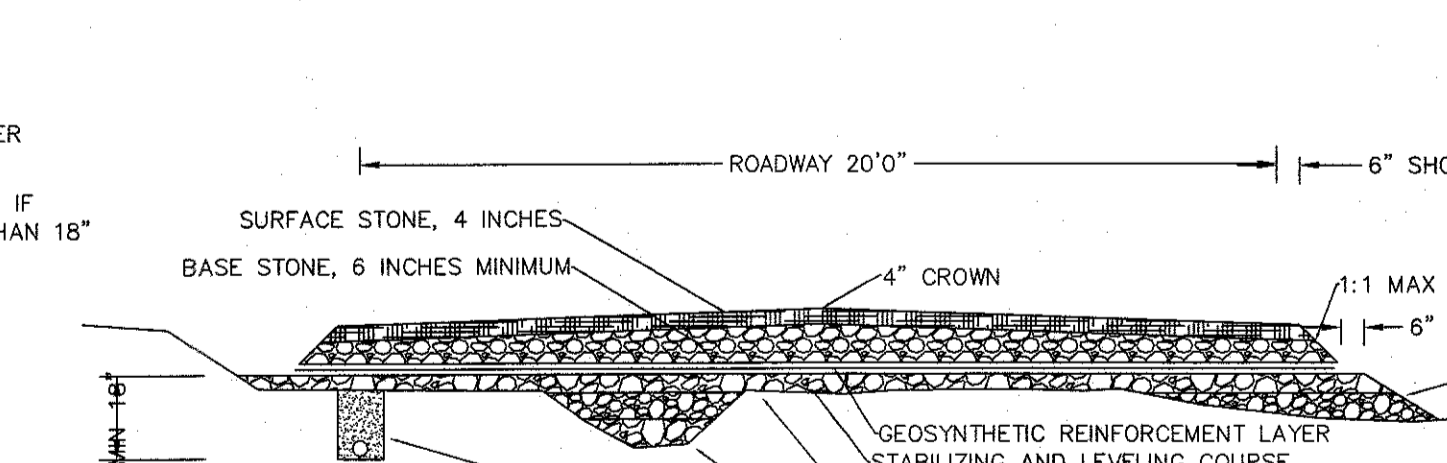

OPTION A

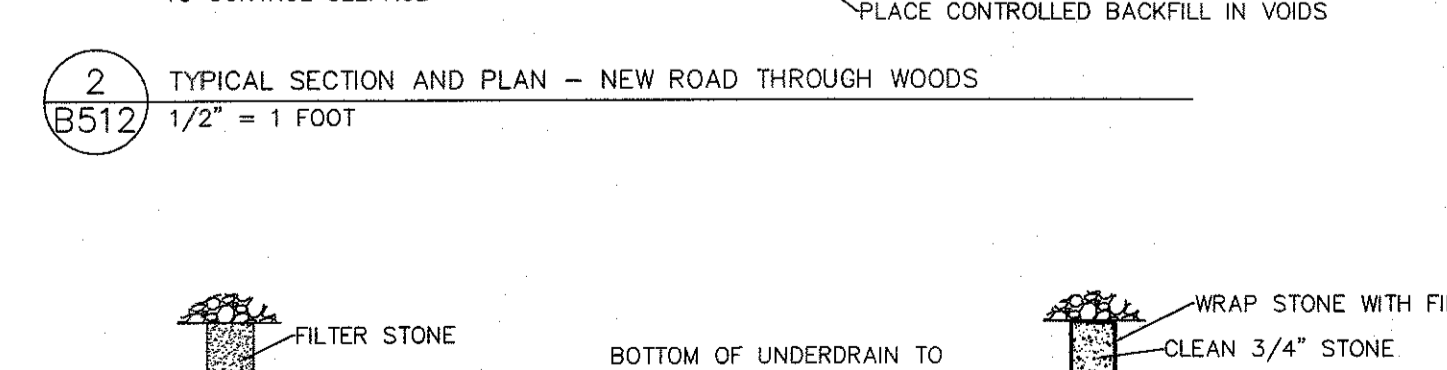

OPTION B

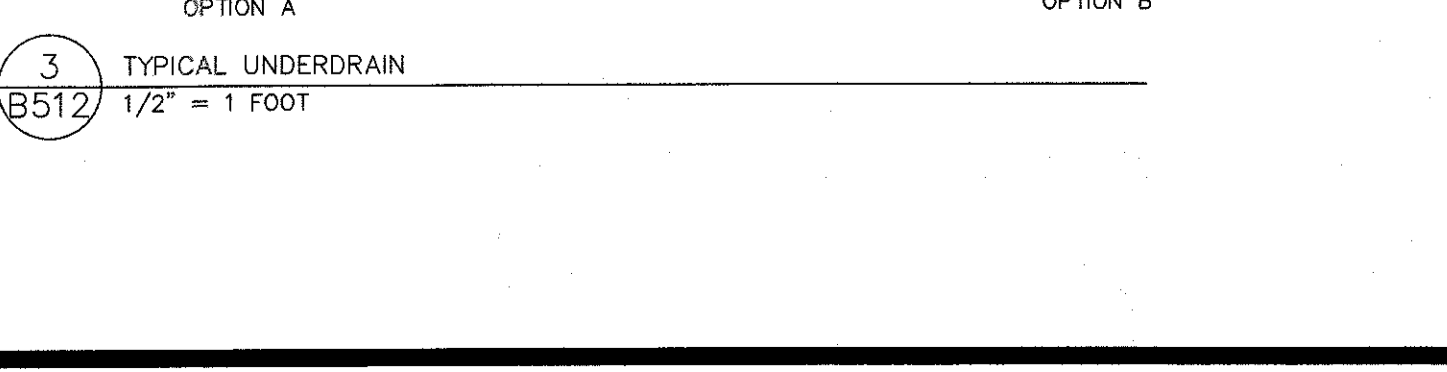

3 B512 1/2" = 1 FOOT

**ROAD CONSTRUCTION PROCEDURES**

- CONSTRUCTION ON EXISTING CLEARED TRAVELED WAY

- BLADE THE SURFACE TO REMOVE ALL GRASS AND VEGETATION, TO THE TOP OF THE SOIL SURFACE. MINIMIZE DISTURBANCE OF SOIL.
- PLACE A FINE-GRADING LAYER OF SURFACE STONE OR SELECT SITE-BORROW SOIL TO FILL ANY LOW SPOTS THAT COULD TRAP WATER UNDER THE ROADWAY.
- COMPACT THE SUBGRADE SURFACE WITH A SMOOTH-DRUM VIBRATORY SOIL ROLLER WITH A MINIMUM NOMINAL SIZE OF 10 TONS.
- PLACE GEOSYNTHETIC REINFORCEMENT OVER THE PREPARED SUBGRADE SURFACE. LAP ALL SEAMS AT LEAST 12 INCHES.
- PLACE BASE STONE OVER THE GEOSYNTHETIC LAYER, WITH A MINIMUM THICKNESS OF SIX INCHES, SHAPED TO PRODUCE A 4-INCH CROWN IN THE CENTER OF THE ROAD. IF THE MAXIMUM THICKNESS OF BASE STONE WILL EXCEED 16 INCHES, PLACE THE STONE IN TWO OR MORE EQUAL LIFTS.
- COMPACT THE BASE STONE WITH AT LEAST SIX VIBRATORY PASSES OF THE ROLLER.
- PLACE AND GRADE THE SURFACE STONE IN A 4-INCH LIFT OVER THE BASE STONE.
- COMPACT THE SURFACE STONE WITH AT LEAST FOUR PASSES OF THE VIBRATORY ROLLER.

**CONSTRUCTION ON NEWLY-CLEARED AREAS**

- FILL ALL BOULDER POCKETS, STUMP HOLES AND OTHER VOIDS WITH THOROUGHLY-COMPACTED BASE STONE OR SURFACE STONE, OR GOOD-QUALITY SITE BORROW SOIL.
- PLACE A STABILIZING AND LEVELING COURSE OF BASE STONE OVER THE SUBGRADE SURFACE. THIS COURSE SHOULD BE AT LEAST FOUR INCHES THICK OVER HIGH SPOTS. IN LOCATIONS WHERE IT WILL EXCEED 12 INCHES THICKNESS, PLACE THIS COURSE IN MULTIPLE LIFTS.
- COMPACT THE STABILIZING AND LEVELING COURSE WITH AT LEAST SIX PASSES OF A SINGLE-DRUM VIBRATORY SOIL ROLLER WITH A NOMINAL WEIGHT OF AT LEAST 7 TONS, EQUIPPED WITH A SHEEPS-FOOT OR DEEP TAMPING-FOOT DRUM.
- FINE-GRADE THE SURFACE OF THE LEVELING COURSE. RE-COMPACT ANY RE-WORKED AREAS WITH A SMOOTH-DRUM ROLLER.
- PLACE GEOSYNTHETIC REINFORCEMENT OVER THE STABILIZING AND LEVELING COURSE. LAP ALL SEAMS AT LEAST 12 INCHES.
- PLACE BASE STONE OVER THE GEOSYNTHETIC LAYER, WITH A MINIMUM THICKNESS OF SIX INCHES, SHAPED TO PRODUCE A 4-INCH CROWN IN THE CENTER OF THE ROAD. IF THE MAXIMUM THICKNESS OF BASE STONE WILL EXCEED 16 INCHES, PLACE THE STONE IN TWO OR MORE EQUAL LIFTS.
- COMPACT THE BASE STONE WITH AT LEAST SIX VIBRATORY PASSES OF A SINGLE-DRUM VIBRATORY ROLLER WITH A NOMINAL WEIGHT OF AT LEAST 10 TONS, EQUIPPED WITH A SMOOTH DRUM.
- PLACE AND GRADE THE SURFACE STONE IN A 4-INCH LIFT OVER THE BASE STONE.
- COMPACT THE SURFACE STONE WITH AT LEAST FOUR PASSES OF THE SMOOTH-DRUM VIBRATORY ROLLER.

**C. MATERIALS**

- BASE STONE SHALL BE CRUSHED STONE, 1-1/2" TO 3" NOMINAL SIZE, CONTAINING SUFFICIENT FINES TO FILL THE VOIDS.
 

BASE STONE	Sieve	% Pass
4"	100	100
2"	40-90	100
1 1/4"	5-20	100
#40	2-20	100
#200	2-10	100
- SURFACE STONE SHALL BE NYSDOT ITEM 304 TYPE 2, CRUSHED STONE FROM LEDGE ROCK.
 


SURFACE STONE	Sieve	% Pass
2"	100	100
1 1/4"	25-80	100
#40	5-40	100
#200	0-10	100

- FILTER STONE SHALL BE NYSDOT ITEM 733-20, TYPE 1 OR TYPE 2. FOR OPTION B, 3/4" STONE SHALL BE ASTM C33 #5, #6, #57 OR #67 SIZE, OR NYSDOT CA-2 OR ITEM 702 #2 SIZE.
 

FILTER TYPE 1	% Pass	FILTER TYPE 2	% Pass
1"	100	1"	100
1 1/2"	100	1 1/2"	100
1 3/4"	0-30	1 3/4"	20-100
#10	0-10	#10	0-15
#20	0-5	#20	0-5
- GEOSYNTHETIC REINFORCEMENT TEN CATE MIRAFI 600X WOVEN REINFORCEMENT GEOTEXTILE OR EQUIVALENT.
- FILTER FABRIC CARTRIDGE MILLS "CARTRIDGE 6X" WOVEN DRAINAGE GEOTEXTILE OF EQUIVALENT.

WARNING - IT IS A VIOLATION OF NEW YORK EDUCATIONAL LAW, SECTION 7209.2, FOR ANY PERSON, UNLESS ACTING UNDER THE DIRECTION OF A LICENSED PROFESSIONAL ENGINEER OR LAND SURVEYOR, TO ALTER THIS DOCUMENT IN ANY WAY. IF ALTERED, THE ALTERING PERSON SHALL COMPLY WITH THE REQUIREMENTS OF NEW YORK EDUCATIONAL LAW, SECTION 7209.2.

ONLY MAPS WITH EMBOSSED SEALS ARE GENUINE COPIES OF THE ORIGINAL WORK AND OPINION. MAPS NOT BEARING EMBOSSED SEALS SHOULD NOT BE RELIED UPON SINCE OTHER THAN EMBOSSED-SEAL COPIES MAY CONTAIN UNAUTHORIZED AND UNDETECTABLE MODIFICATIONS, DELETIONS, ADDITIONS AND CHANGES.

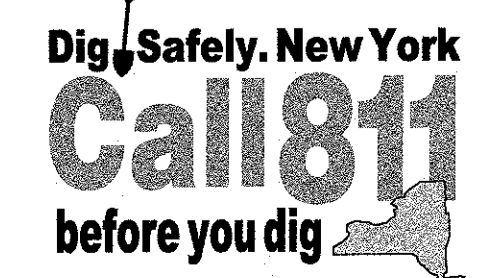

**ARDEN CONSULTING ENGINEERS, PLLC**  
 P.O. BOX 340 MONROE, N.Y.  
 TEL: (845) 782-8114  
 WWW.ARDENCONSULTING.NET

**AMENDED 5 MW AC SOLAR FARM SITE PLAN FOR DARRIGO**  
 84 LAKESIDE AVENUE  
 TOWN OF NEWBURGH - ORANGE COUNTY, N.Y.


**CONSTRUCTION DETAILS**

#REV.	BY	DATE	DESCRIPTION
#7	MM	1/18/24	PHASING PLAN PREPARATION
#6	MM	10/12/23	DEC HW FENCE REMOVED ON PROPOSED SOLAR FARM PLANS
#5	MM	3/16/21	PER 3/16/21 SITE VISIT
#4	MM	2/23/21	PER WS COMMENTS
#3	MM	1/11/21	PER PB COMMENTS
#2	MM	10/30/20	FINAL PLAN PREPARATION
#1	MM	1/24/20	REVISION PER MHE 1/2/20 COMMENT LETTER

THIS SHEET IS NOT VALID WITHOUT ALL OF THE SHEETS THAT COMPRISE THE SET

**JOB#:** 16-014  
**SCALE:** AS NOTED  
**ORIGINAL DATE:** 12-16-19  
**DRAWN:** MM  
**CHECKED:** MM  
**SHEET NO:** 08 of 09

**MICHAEL A. MORGANTE, P.E.**  
 LIC. NO. 78577

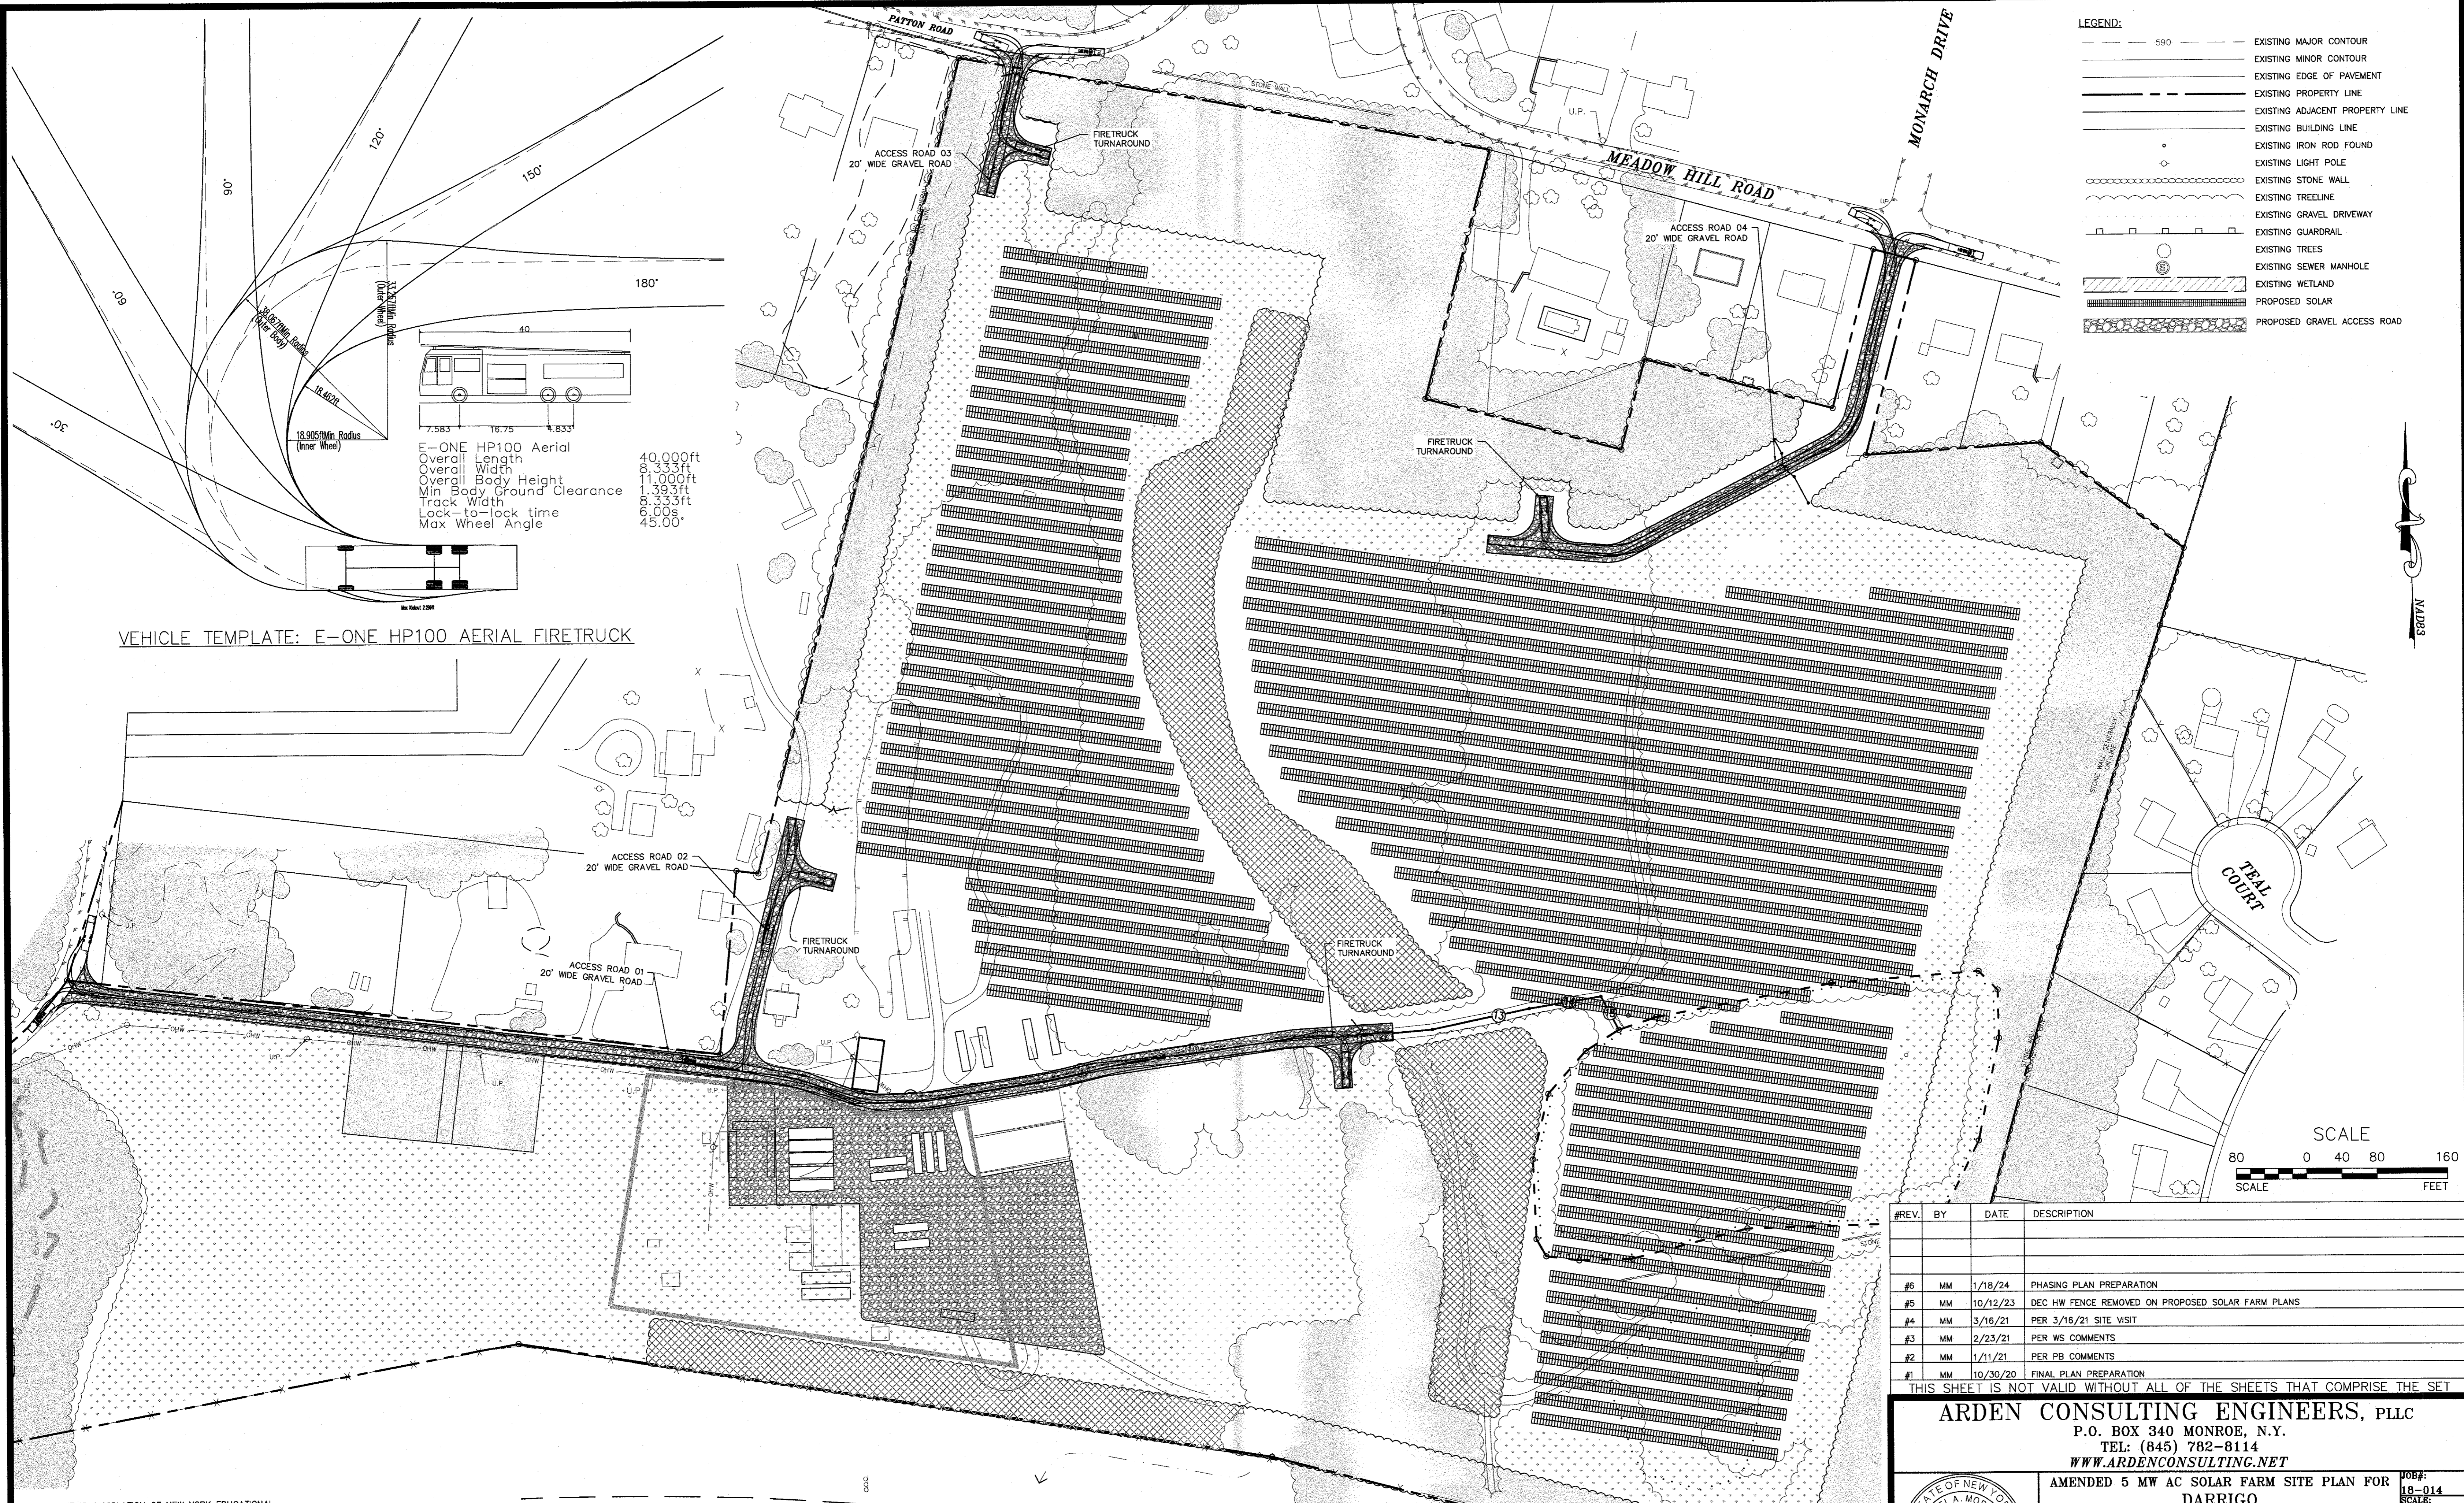

- LEGEND:**
- 590 --- EXISTING MAJOR CONTOUR
  - EXISTING MINOR CONTOUR
  - EXISTING EDGE OF PAVEMENT
  - EXISTING PROPERTY LINE
  - EXISTING ADJACENT PROPERTY LINE
  - EXISTING BUILDING LINE
  - EXISTING IRON ROD FOUND
  - EXISTING LIGHT POLE
  - EXISTING STONE WALL
  - EXISTING TREELINE
  - EXISTING GRAVEL DRIVEWAY
  - EXISTING GUARDRAIL
  - EXISTING TREES
  - EXISTING SEWER MANHOLE
  - EXISTING WETLAND
  - PROPOSED SOLAR
  - PROPOSED GRAVEL ACCESS ROAD

E-ONE HP100 Aerial  
 Overall Length 40.000ft  
 Overall Width 8.333ft  
 Overall Body Height 11.000ft  
 Min Body Ground Clearance 1.393ft  
 Track Width 8.333ft  
 Lock-to-lock time 6.00s  
 Max Wheel Angle 45.00°


VEHICLE TEMPLATE: E-ONE HP100 AERIAL FIRETRUCK

WARNING - IT IS A VIOLATION OF NEW YORK EDUCATIONAL LAW, SECTION 7209.2, FOR ANY PERSON, UNLESS ACTING UNDER THE DIRECTION OF A LICENSED PROFESSIONAL ENGINEER OR LAND SURVEYOR, TO ALTER THIS DOCUMENT IN ANY WAY. IF ALTERED, THE ALTERING PERSON SHALL COMPLY WITH THE REQUIREMENTS OF NEW YORK EDUCATIONAL LAW, SECTION 7209.2

ONLY MAPS WITH EMBOSSED SEALS ARE GENUINE COPIES OF THE ORIGINAL WORK AND OPINION. MAPS NOT BEARING EMBOSSED SEALS SHOULD NOT BE RELIED UPON SINCE OTHER THAN EMBOSSED-SEAL COPIES MAY CONTAIN UNAUTHORIZED AND UNDETECTABLE MODIFICATIONS, DELETIONS, ADDITIONS AND CHANGES.

**Dig Safely, New York**  
**Call 811**  
 before you dig

INTERSTATE 84  
 TURNING DIAGRAMS  
 SCALE: 1"=80'

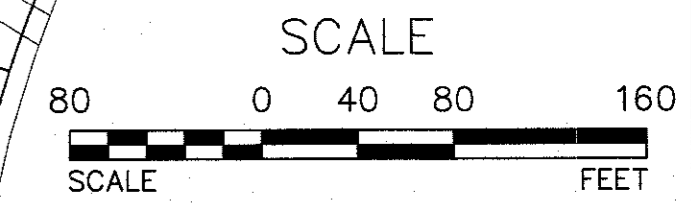

#	REV.	BY	DATE	DESCRIPTION
#6	MM		1/18/24	PHASING PLAN PREPARATION
#5	MM		10/12/23	DEC HW FENCE REMOVED ON PROPOSED SOLAR FARM PLANS
#4	MM		3/16/21	PER 3/16/21 SITE VISIT
#3	MM		2/23/21	PER WS COMMENTS
#2	MM		1/11/21	PER PB COMMENTS
#1	MM		10/30/20	FINAL PLAN PREPARATION

THIS SHEET IS NOT VALID WITHOUT ALL OF THE SHEETS THAT COMPRISE THE SET

**ARDEN CONSULTING ENGINEERS, PLLC**  
 P.O. BOX 340 MONROE, N.Y.  
 TEL: (845) 782-8114  
 WWW.ARDENCONSULTING.NET

AMENDED 5 MW AC SOLAR FARM SITE PLAN FOR  
**DARRIGO**  
 84 LAKESIDE AVENUE  
 TOWN OF NEWBURGH - ORANGE COUNTY, N.Y.

**TURNING DIAGRAMS**

MICHAEL A. MORGANTE, P.E.  
 LIC. NO. 78877


JOB#: 18-014  
 SCALE: AS NOTED  
 ORIGINAL DATE: 12-16-19  
 DRAWN: MM  
 CHECKED: MM  
 SHEET NO. 09 of 09

**PLANTING NOTES:**


- ALL NEW PLANT MATERIAL SHALL CONFORM TO THE MINIMAL GUIDELINES ESTABLISHED BY THE AMERICAN STANDARD FOR NURSERY STOCK PUBLISHED BY THE AMERICAN ASSOCIATION OF NURSERYMEN, INC. PROVIDE QUALITY, SIZE, GENUS, SPECIES, VARIETY OF TREES AND SHRUBS INDICATED, AND ROOT BALL SIZE COMPLYING WITH APPLICABLE REQUIREMENTS OF ANSI Z60.1 "AMERICAN STANDARD FOR NURSERY STOCK." ALL PLANTS SHOULD BE NURSERY GROWN UNDER CLIMATIC CONDITIONS SIMILAR TO THOSE IN THE LOCALITY OF THE PROJECT.
- PLANT SIZES: MEASURE TREES AND SHRUBS ACCORDING TO ANSI Z60.1 WITH BRANCHES AND TRUNKS OR CANES IN THEIR NORMAL POSITION. TAKE CALIPER MEASUREMENTS 6 INCHES ABOVE GROUND FOR TREES UP TO 4-INCH CALIPER SIZE, MEASURE MAIN BODY OF TREE OR SHRUB FOR HEIGHT AND SPREAD, DO NOT MEASURE BRANCHES OR ROOTS TIP-TO-TIP.
- ALL CONTAINER GROWN PLANTS SHALL BE SIZED ACCORDING TO ANSI Z60.1 FOR TYPE AND SIZE OF PLANT REQUIRED. PLANTS SHALL BE PREMIUM QUALITY, APPEAR 'FULL', OR 'HEAVY' WITHIN THEIR CONTAINER, AND BE REPRESENTATIVE OF THE CONTAINER SIZE SPECIFIED. PLANTS DEEMED TO BE SUBSTANDARD IN SIZE BY THE LANDSCAPE ARCHITECT WILL BE REJECTED.
- ALL NEW PLANTS TO BE BALLED AND BURLAPPED OR CONTAINER GROWN UNLESS OTHERWISE NOTED ON PLANT LIST.
- TREES SHOULD BE FRESHLY DUG DURING THE SEASON OF PLANTING. PLANTS KNOWN AS FALL DIG HAZARDS SHALL BE DUG IN THE SPRING ONLY.
- THE CONTRACTOR SHALL SUPPLY ALL NEW PLANT MATERIAL IN QUANTITIES SUFFICIENT TO COMPLETE THE PLANTING SHOWN ON THE DRAWINGS.
- IN GENERAL, PLANT SPECIES SUBSTITUTIONS WILL NOT BE ACCEPTED. IF SPECIFIED MATERIAL IS NOT OBTAINABLE, CONTRACTOR SHALL SUBMIT PROOF OF NON-AVAILABILITY TO LANDSCAPE ARCHITECT ALONG WITH PROPOSED SUBSTITUTION. ANY PROPOSED SUBSTITUTIONS OF PLANT SPECIES SHALL BE MADE WITH PLANTS OF EQUIVALENT OVERALL FORM, HEIGHT, SIZE, BRANCHING HABIT, FLOWER, LEAF, COLOR, FRUIT AND CULTURE, AND ONLY AFTER WRITTEN APPROVAL OF THE LANDSCAPE ARCHITECT.
- THE LANDSCAPE ARCHITECT RETAINS THE RIGHT TO INSPECT TREES AND SHRUBS FOR SIZE AND CONDITION OF BALLS AND ROOT SYSTEMS, INSECTS, INJURIES AND LATENT DEFECTS, AND TO REJECT UNSATISFACTORY OR DEFECTIVE MATERIAL AT ANY TIME DURING PROGRESS OF WORK. CONTRACTOR SHALL REMOVE REJECTED TREES OR SHRUBS IMMEDIATELY FROM PROJECT SITE.
- CONTRACTOR SHALL LOCATE AND VERIFY ALL EXISTING UTILITY LINES PRIOR TO PLANTING AND SHALL REPORT ANY CONFLICTS TO THE LANDSCAPE ARCHITECT.
- THE CONTRACTOR SHALL STAKE THE LOCATIONS OF ALL PROPOSED PLANT MATERIAL AND PLANT BEDS FOR APPROVAL BY THE DEVELOPER OR DEVELOPER'S REPRESENTATIVE PRIOR TO THE COMMENCEMENT OF PLANTING.
- INSTALLED PLANTS SHALL BEAR THE SAME RELATIONSHIP TO PROPOSED GRADE AS THEY BORE TO PREVIOUS GRADE. NO TREES SHALL BE PLANTED BEFORE ACCEPTANCE OF ROUGH GRADING.
- CONTRACTOR SHALL PROVIDE LONG LASTING, SLOW RELEASE STARTER FERTILIZER IN EACH PLANTING PIT FOR TREES, SHRUBS AND PERENNIALS.
- ALL PLANT BEDS SHALL RECEIVE THREE INCHES (3") OF SHREDDED BARK MULCH. MULCH SHALL BE FREE FROM DELETERIOUS MATERIALS AND SUITABLE AS A TOP DRESSING OF TREES AND SHRUBS, CONSISTING OF DOUBLE HAMMERED SHREDDED BARK MULCH COMPRISED OF EITHER HARDWOOD OR SOFTWOOD SHREDDED BARK. SHREDDED BARK MULCH SHALL NOT EXCEED 3" IN GREATEST DIMENSION, AND SHALL BE DARK BROWN IN COLOR.
- PLANTS SHALL BE DELIVERED ONLY AS THEY CAN BE INSTALLED IN REASONABLE TIME. ALL PLANTS ARE SUBJECT TO INSPECTION AT DELIVERY BY THE LANDSCAPE ARCHITECT / OWNER'S REPRESENTATIVE.
- IF DISCREPANCIES EXIST BETWEEN THE NUMBER OF PLANTS DRAWN ON THE PLANTING PLAN AND THE NUMBER OF PLANTS IN THE PLANT LIST, THE PLANTING PLAN SHALL GOVERN.
- MAINTENANCE SHALL BEGIN IMMEDIATELY AFTER EACH PLANT IS PLANTED AND SHALL CONTINUE FOR A MINIMUM 30-DAY MONITORING PERIOD AFTER NOTIFICATION OF SUBSTANTIAL COMPLETION, AND UNTIL FINAL ACCEPTANCE, WHICHEVER IS GREATER. MAINTENANCE INCLUDES PRUNING, WEEDING, WATERING, FERTILIZATION, AND RE-SEEDING AS NECESSARY.
- PROTECT PLANTS FROM DAMAGE DUE TO LANDSCAPE OPERATIONS AND OPERATIONS OF OTHER CONTRACT MAINTENANCE PERIODS. TREAT, REPAIR, OR REPLACE DAMAGED ORS AND TRADES. MAINTAIN PROTECTION DURING INSTALLATION AND PLANTINGS.
- FOLLOWING THE ISSUANCE OF THE CERTIFICATE OF SUBSTANTIAL COMPLETION TO THE CONTRACTOR, THE CONTRACTOR SHALL MAINTAIN THE PLANTS FOR THE MAINTENANCE PERIOD SPECIFIED IN THIS SECTION.
- ACCEPTANCE STANDARDS AT END OF THE MAINTENANCE PERIOD:
  - PLANTS SHALL BE FREE OF FROST CRACKS; SUN SCALD; DAMAGE DUE TO INSECTS, PESTS, AND DISEASE; STRUCTURAL DEFECTS; AND DAMAGE RESULTING FROM MACHINERY OR TOOLS. ALL PLANTS REGARDLESS OF THE SEASON OF REVIEW SHALL HAVE A MINIMUM OF 75 PERCENT HEALTHY, BALANCED BRANCHING STRUCTURE WITH A HEALTHY TERMINAL LEADER(S) WITH VIABLE TERMINAL BUD(S). TREES SHALL BE PLUMB AND SHOW NO SIGNS OF UNEVEN SETTLING OR LEANING.
  - LAWN AREAS SHALL HAVE A HEALTHY, UNIFORM STAND OF GRASS FREE OF WEEDS, SURFACE IRREGULARITIES, WITH COVERAGE EXCEEDING 90% OVER ANY 10 SQ. FT. AND BARE SPOTS NOT EXCEEDING 5"X5".
- GUARANTEE: CONTRACTOR SHALL GUARANTEE ALL PLANT MATERIAL TO REMAIN ALIVE AND BE IN A HEALTHY, VIGOROUS CONDITION FOR A PERIOD OF TWO YEARS AFTER FINAL ACCEPTANCE OF PLANTING WORK, AGAINST DEFECTS INCLUDING DEATH AND UNSATISFACTORY WORK. CONTRACTOR SHALL REPLACE ALL PLANTS THAT ARE MORE THAN 25% DEAD OR, AS DETERMINED BY THE LANDSCAPE ARCHITECT, ARE IN AN UNHEALTHY OR UNSIGHTLY CONDITION. CONTRACTOR SHALL BEAR THE COST OF COMPLETE REPLACEMENT(S). REPLACEMENTS SHALL BE OF THE SAME SIZE AND SPECIES AS SPECIFIED ON THE PLANTING LIST.
- SEED MIXES TO BE BROADCAST SPREAD: FRESH, CLEAN, DRY, NEW-CROP SEED COMPLYING WITH AOSA'S "RULES FOR TESTING SEEDS" FOR PURITY AND GERMINATION TOLERANCES. PROVIDE SEED MIXTURE COMPOSED OF SPECIES, PROPORTIONS AND MINIMUM PERCENTAGES OF PURITY, GERMINATION, AND MAXIMUM PERCENTAGE OF WEED SEED, AS FOLLOWS:
 

Erosion Control & Revegetation for Sloped Areas:  
Ernst Seed Mix ERNMX-181 (Native Steep Slope Mix w/Annual Ryegrass) or approved equal Seeding Rate: 60 lb per acre, or 1.5 lb per 1,000 sq ft


Buffer Area along I-84 and East Property Boundary:  
Ernst Seed Mix ERNMX-111 (Ernst Native Habitat for Strip Mimes Mix) or approved equal Seeding Rate: 20 lb per acre
- ALL SOIL AND TOPSOIL SHALL REMAIN ON SITE AND WILL NOT BE TRUCKED OFF SITE. REFER TO THE SOIL MANAGEMENT PLAN FOR THE DEC REMEDIATION AREA REQUIREMENTS.

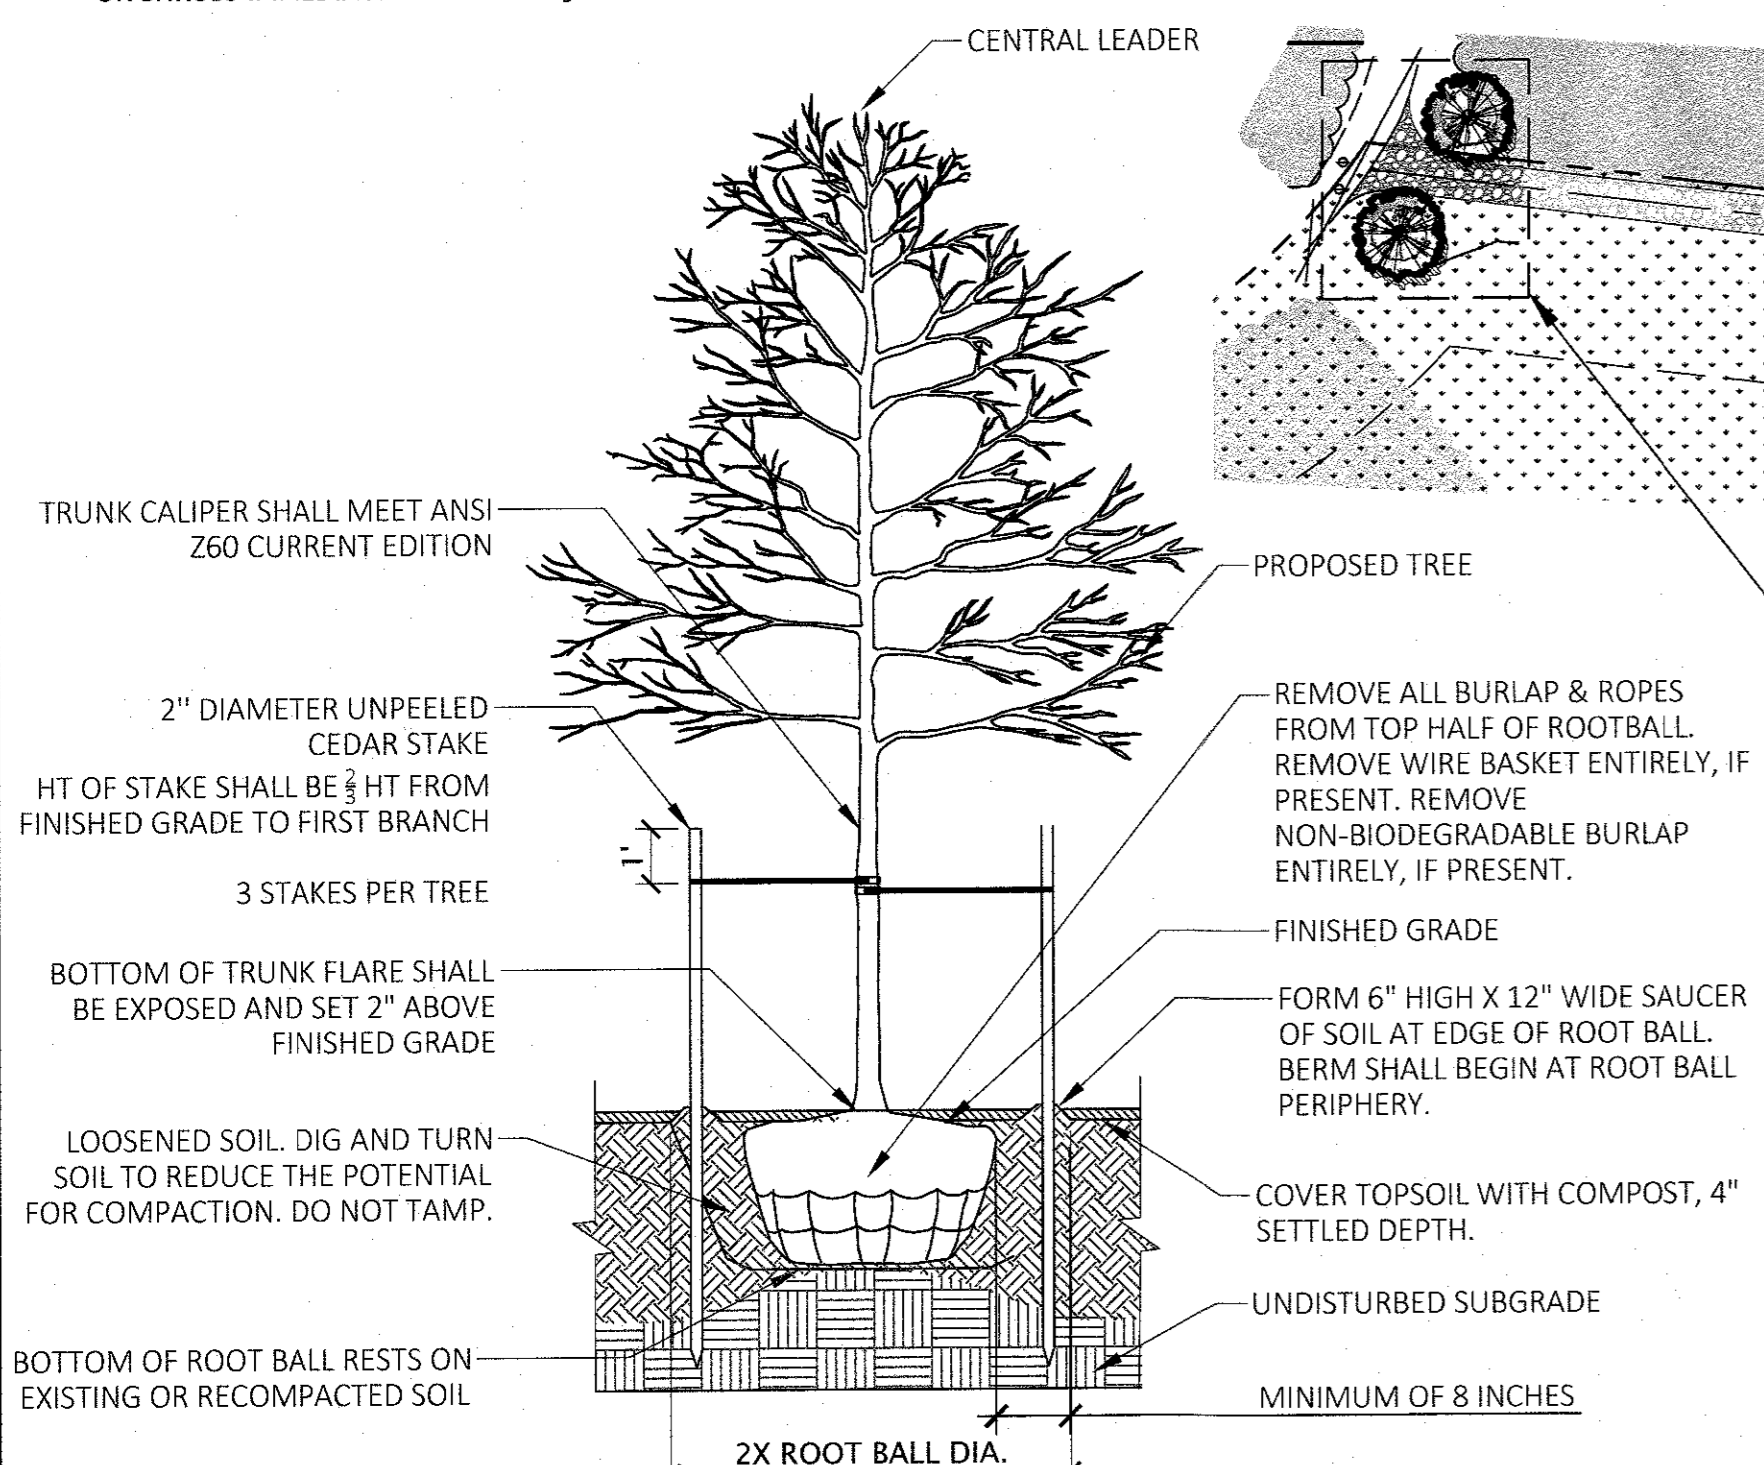


**1 TREE PLANTING DETAIL**  
SCALE: NTS  
CROSS REFERENCE: NONE

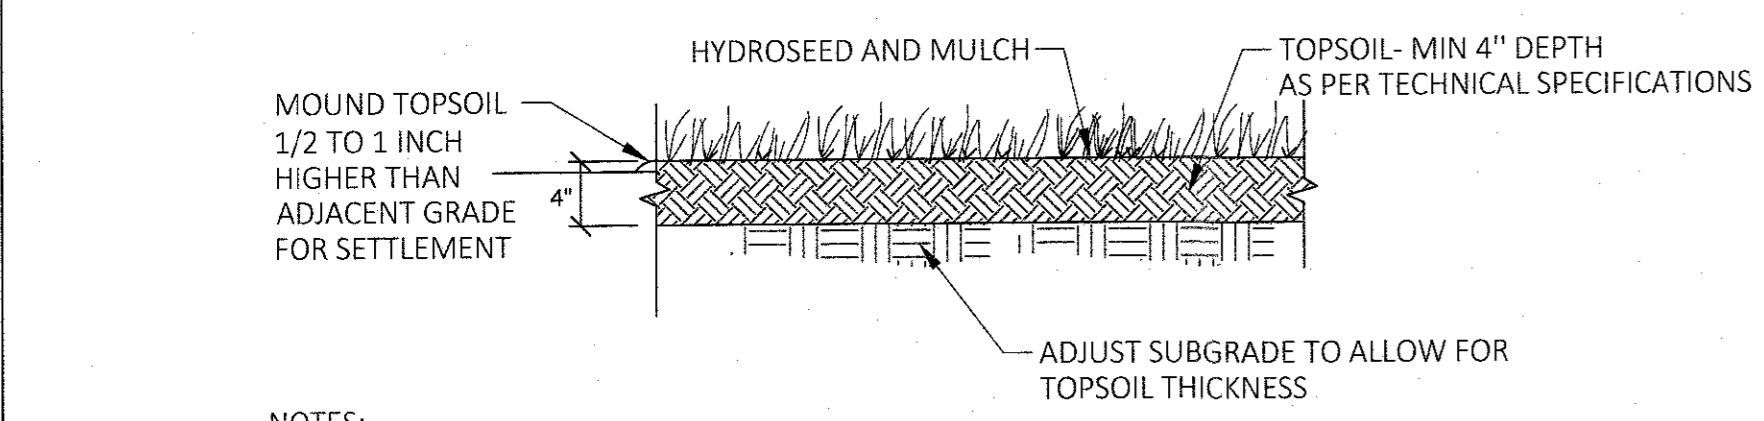


**2 LAWN AND WILDFLOWER SEEDING DETAIL**  
SCALE: NTS  
CROSS REFERENCE: NONE

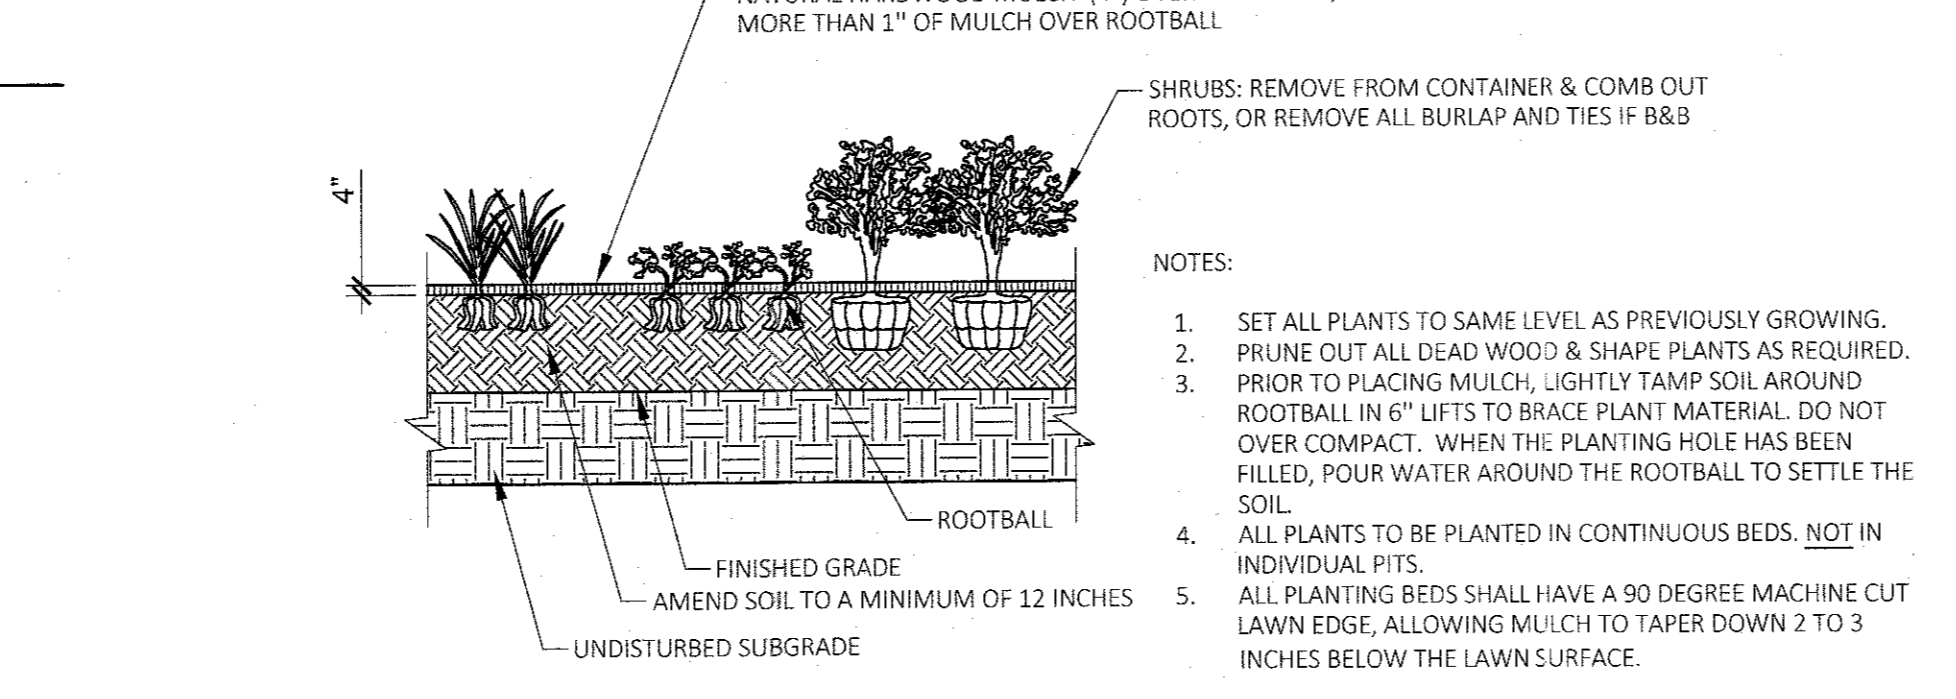

**3 SHRUB AND PERENNIAL PLANTING DETAIL**  
SCALE: NTS  
CROSS REFERENCE: NONE

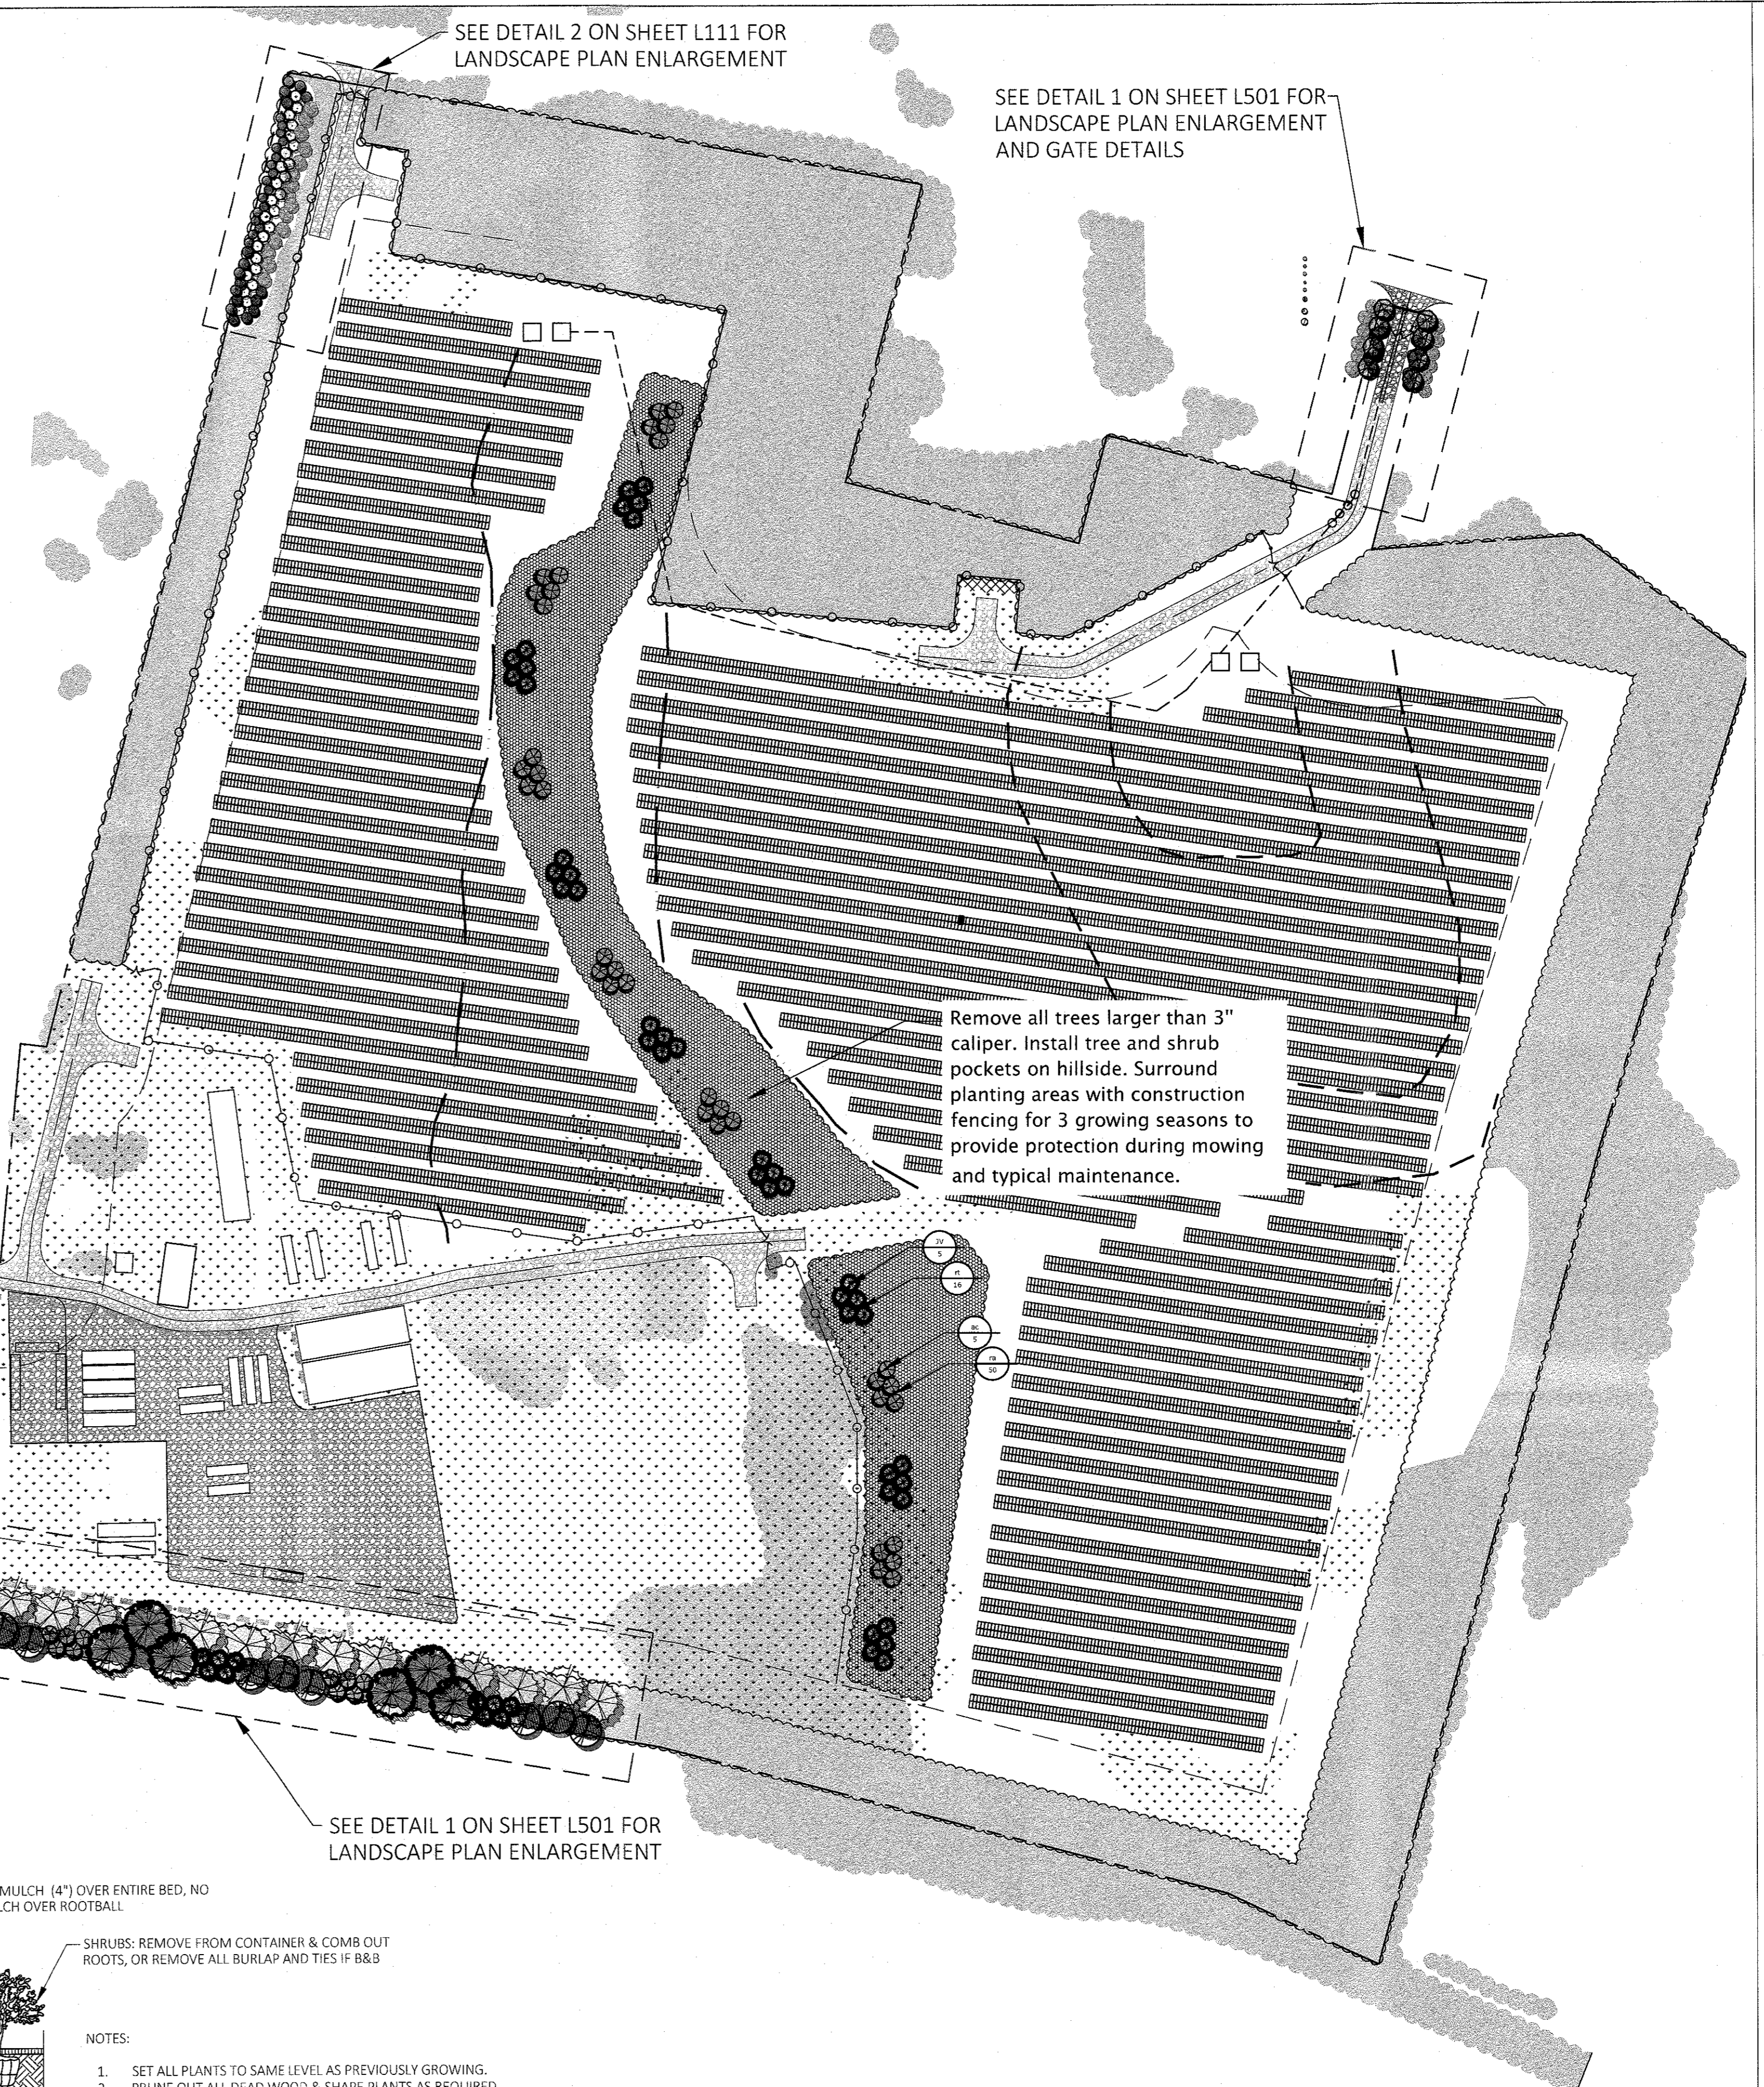



ULS  
Landscape Architecture + Environmental Services + Planning

---

CONSULTANT

---

PROJECT  
**5 MW AC SOLAR FARM SITE PLAN**  
JANUARY 22, 2024

---

CLIENT  
DARRIGO  
84 LAKESIDE AVENUE  
NEWBURGH, NY

---

REV#2		
REV#1		
CD		
DD		
SD		
MARK	DATE	DESCRIPTION

---

PROJECT NO: 33-23  
DRAWING ID:

---

DRAWN BY: RG    CHK'D BY: EM  
SCALE:

---


SHEET TITLE  
**LANDSCAPE PLAN**


---

L-110

---


SHEET 1 OF 4

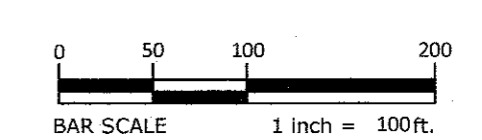

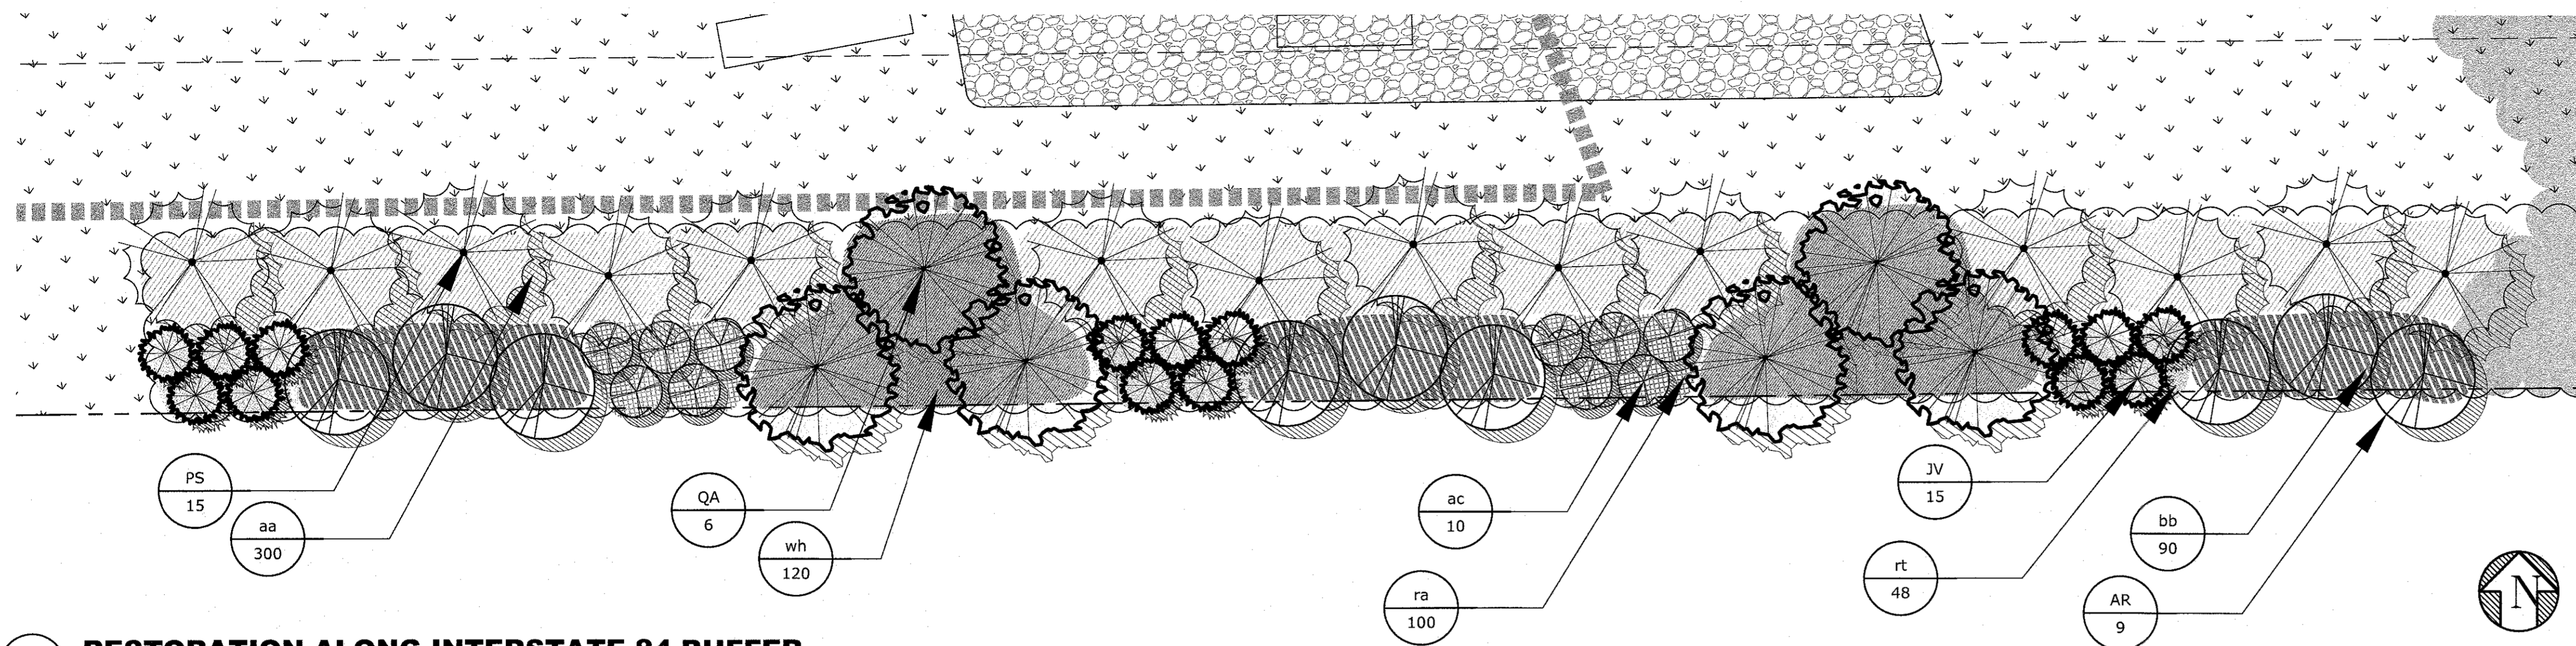

**1 RESTORATION ALONG INTERSTATE 84 BUFFER**

SCALE: 1" = 30'  
CROSS REFERENCE: NONE

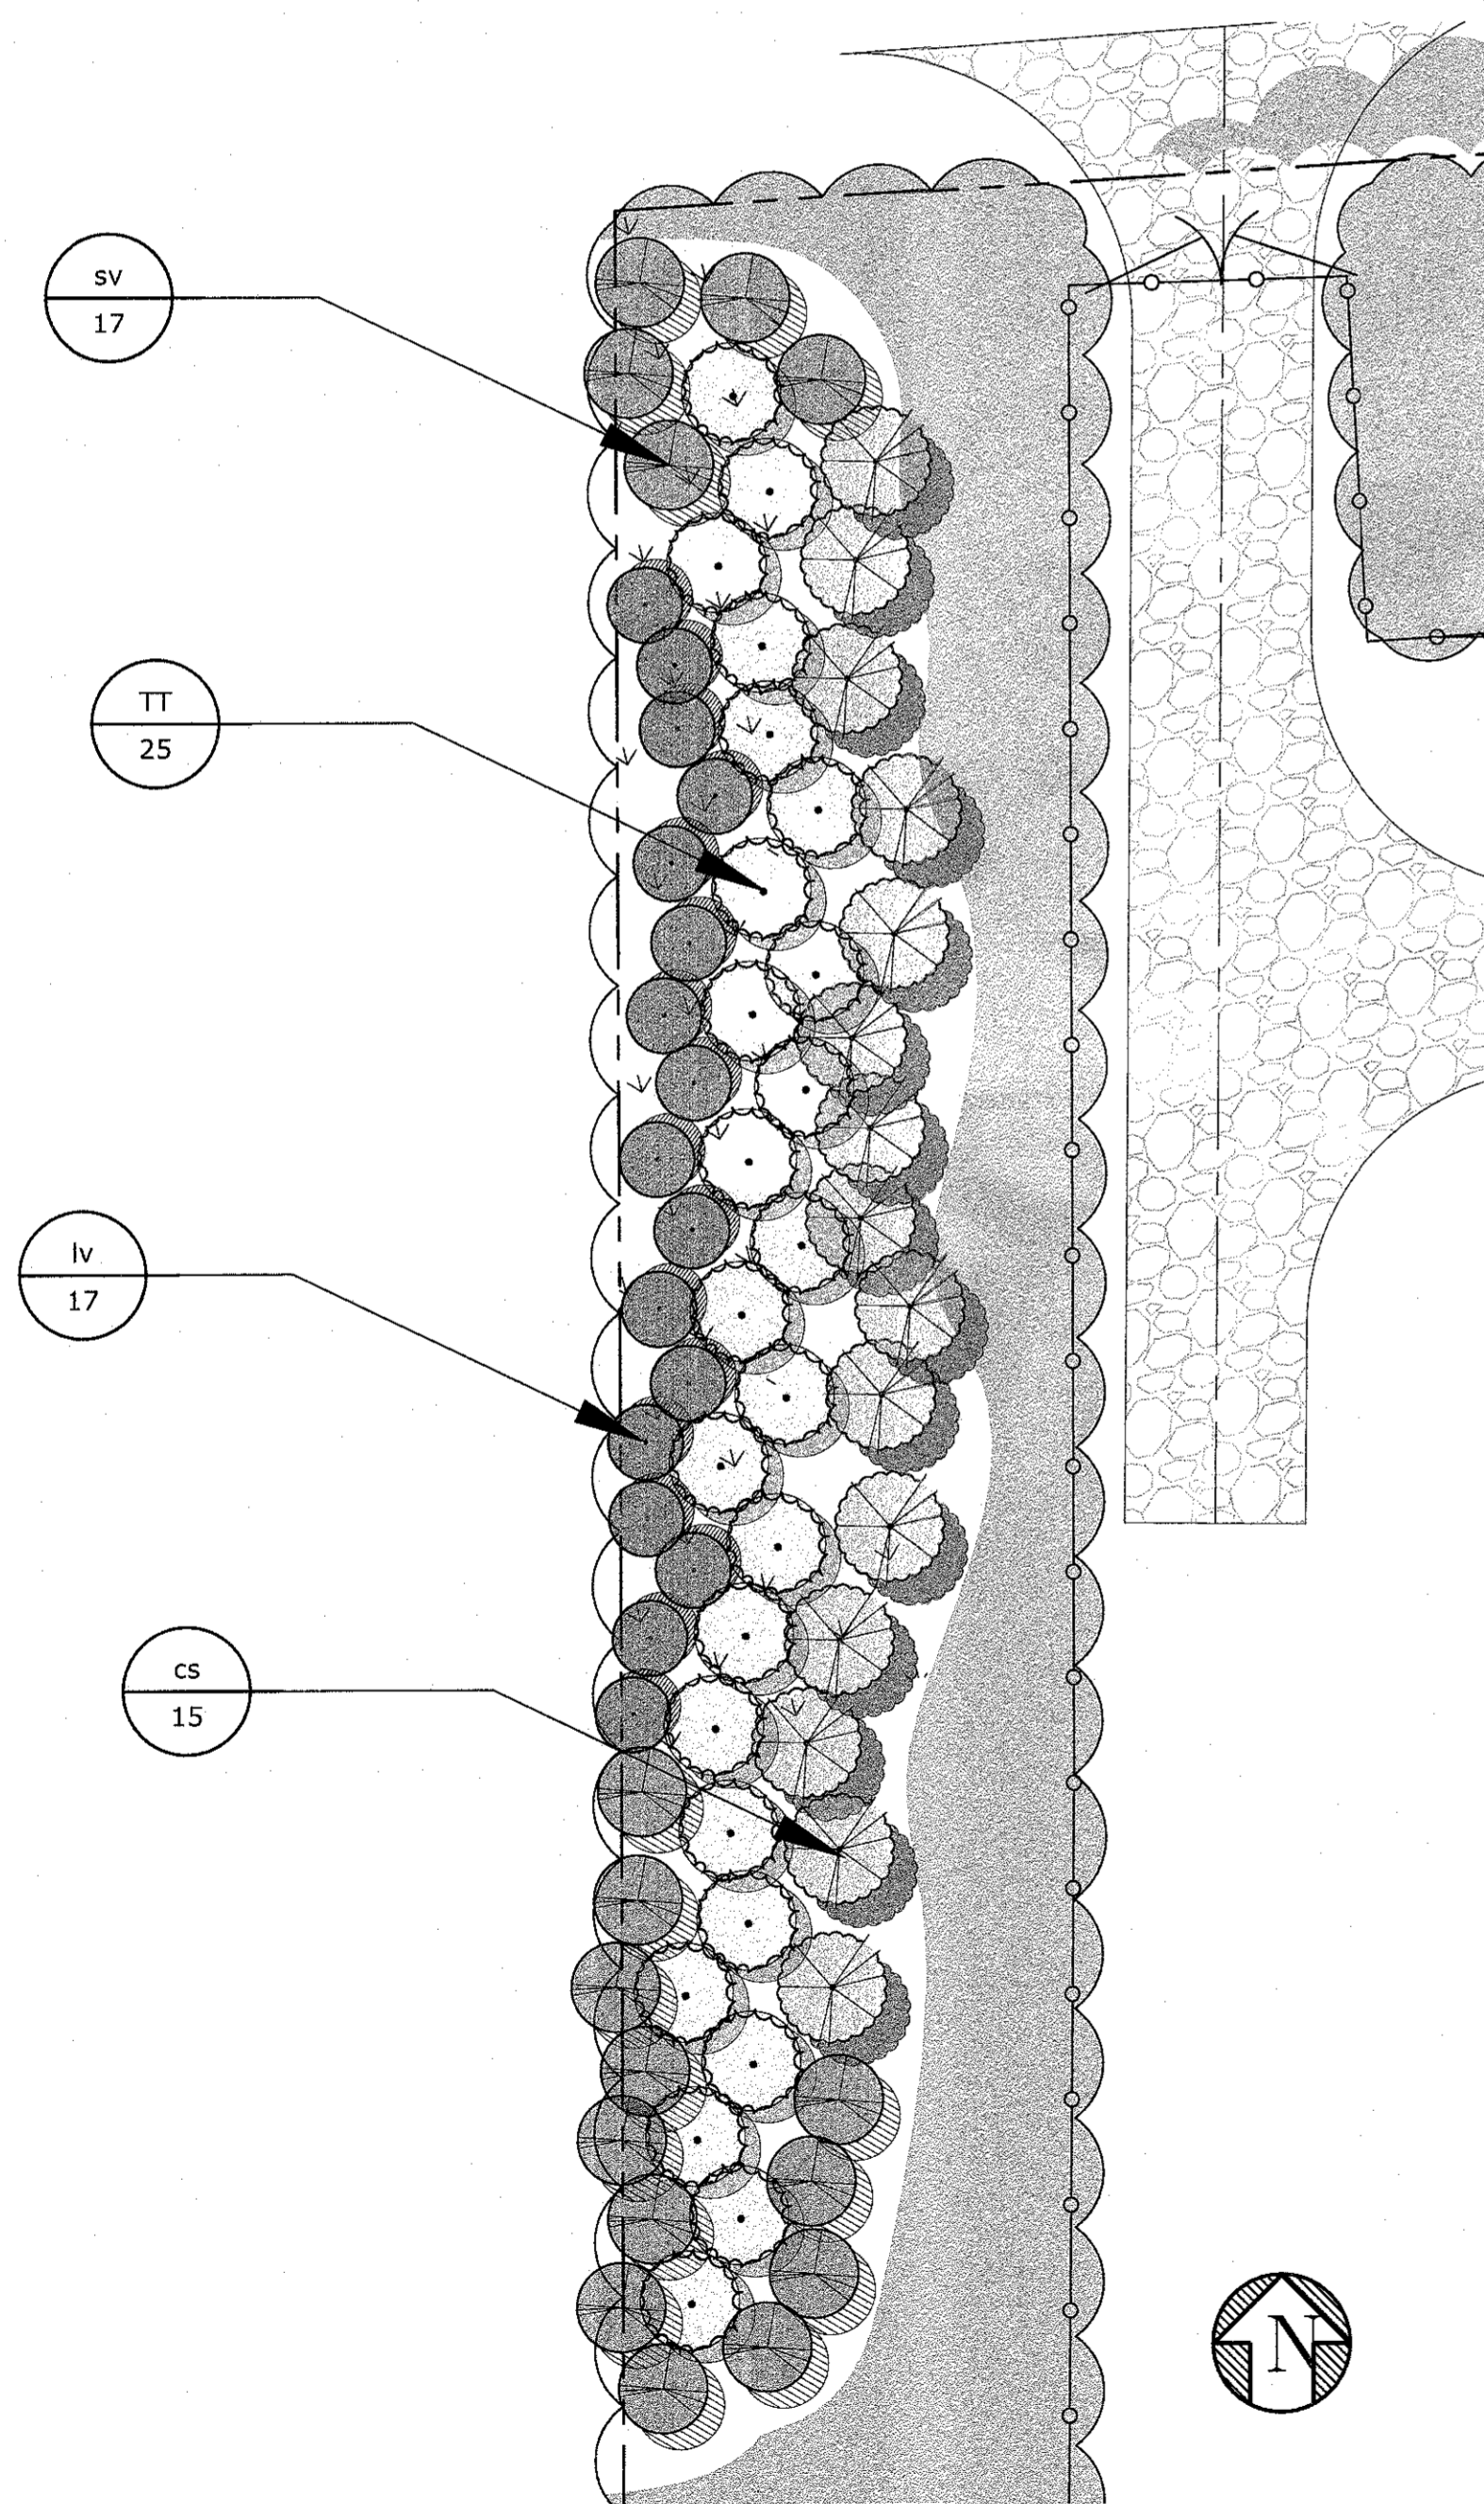

**2 SCREENING AT RESIDENCE ON PATTON ROAD**

SCALE: 1" = 20'  
CROSS REFERENCE: NONE

#	Abbr.	Botanical Name	Common Name	Mature Height	Planting Size	Spacing
Trees						
9	AR	Acer rubrum	Red Maple	40-75'	#15 Cont., 8' height min.	As shown on plans
55	JV	Juniperus virginiana	Eastern Red Cedar	30'	#15 Cont., 8' height min.	As shown on plans
8	QA	Quercus alba	White Oak	50-80'	2-2.5" Cal. B&B, 12' height min.	As shown on plans
15	PS	Pinus strobus	White Pine	50-80'	6-8' Height, B&B	As shown on plans
25	TT	Thuja occidentalis 'Techny'	Techny Arborvitae	12'-15'	7-8' Height, B&B	As shown on plans
Shrubs						
53	ac	Amelanchier X grandiflora	Autumn Brilliance Serviceberry	6-20'	#7 MS, 6-8' height min.	As shown on plans
300	aa	Aronia arbutifolia	Red Chokeberry	5-10'	#3, 36" height min.	5' O.C., As Shown
450	ra	Rhus aromatica	Fragrant Sumac	2'	#3 Cont., 36" height min.	As shown on plans
90	bb	Aesculus parviflora	Bottlebrush Buckeye	8-12'	#3 Cont., 36" height min.	As shown on plans
120	wh	Hamamelis virginiana	Witchhazel	8-10'	#3 Cont., 36" height min.	As shown on plans
25	cs	Cornus sericea	Red Twig Dogwood	6-9'	#3 Cont., 36" height min.	5' O.C., As Shown
29	sv	Spirea x vanhouttei	Bridal Wreath Spirea	5-8'	#3 Cont., 36" height min.	5' O.C., As Shown
13	iv	Ilex verticillata 'Winter Gold'	Winterberry 'Winter Gold'	5-8'	#3 Cont., 36" height min.	5' O.C., As Shown
4	ivj	Ilex verticillata 'Jim Dandy'	Winterberry 'Jim Dandy'	3-6'	#3 Cont., 36" height min.	5' O.C., As Shown
6	tm	Ilex glabra	Ink Berry	4-6'	#3 Cont., 36 height min.	As shown on plans
176	rt	Rhus typhina	Staghorn Sumac	15-25'	#3 Cont., 36" height min.	8' O.C., As Shown
26	fg	Fotherfilla gardenii	Dwarf Fothergilla	3-4'	#3 Cont., 36" height min.	As shown on plans
PERENNIALS						
18	ca	Calamagrostis x acutifolia 'Karl Forester'	Karl Forester Feather Reed Grass	4-5'	#2 Cont., 24" height min.	As shown on plans
10	er	Panicum virgatum Cloud Nine	Cloud Nine Switch Grass	5-7'	#2 Cont., 24" height min.	As shown on plans
68	ss	Sedum spectabile 'Autumn Joy'	Autumn Joy Sedum	18-24"	#1 Cont., 12" height min.	As shown on plans

**3 PLANTING SCHEDULE**

SCALE: NTS  
CROSS REFERENCE: NONE

PROJECT  
**5 MW AC SOLAR FARM SITE PLAN**  
JANUARY 22, 2024

CLIENT  
**DARRIGO**  
84 LAKESIDE AVENUE  
NEWBURGH, NY

REV#2		
REV#1		
CD		
DD		
SD		
MARK	DATE	DESCRIPTION

PROJECT NO: 33-23  
DRAWING ID:

DRAWN BY: RG CHK'D BY: EM  
SCALE:

SHEET TITLE  
**LANDSCAPE PLAN ENLARGEMENTS**



REV#2		
REV#1		
CD		
DD		
SD		
MARK	DATE	DESCRIPTION

PROJECT NO: 33-23  
DRAWING ID:



DRAWN BY: RG CHK'D BY: EM  
SCALE:

SHEET TITLE

ENTRANCE  
PIER  
ELEVATIONS &  
PLANS

L-501

SHEET 3 OF 4

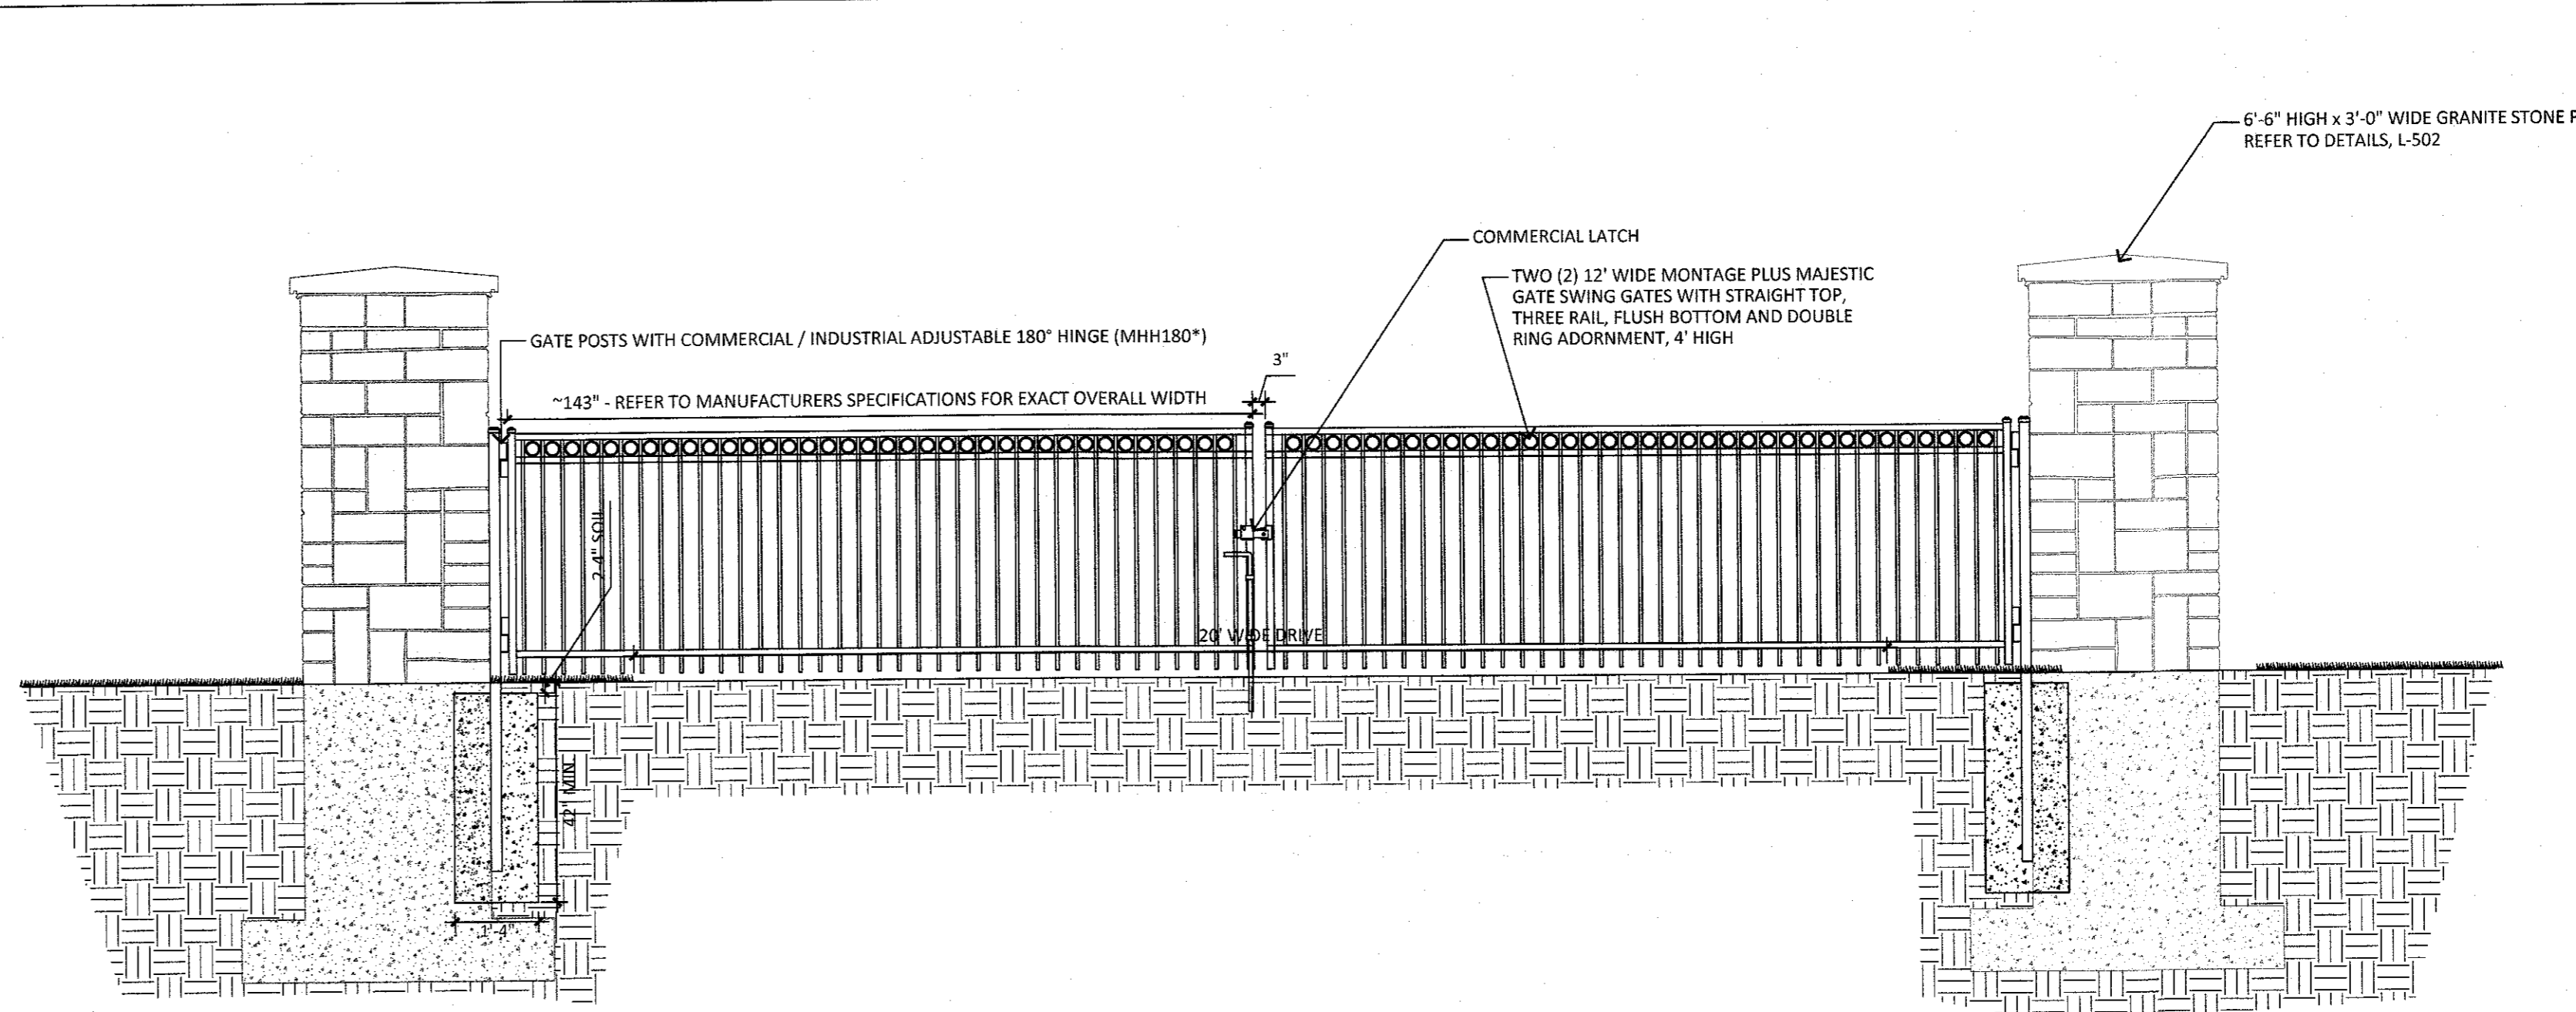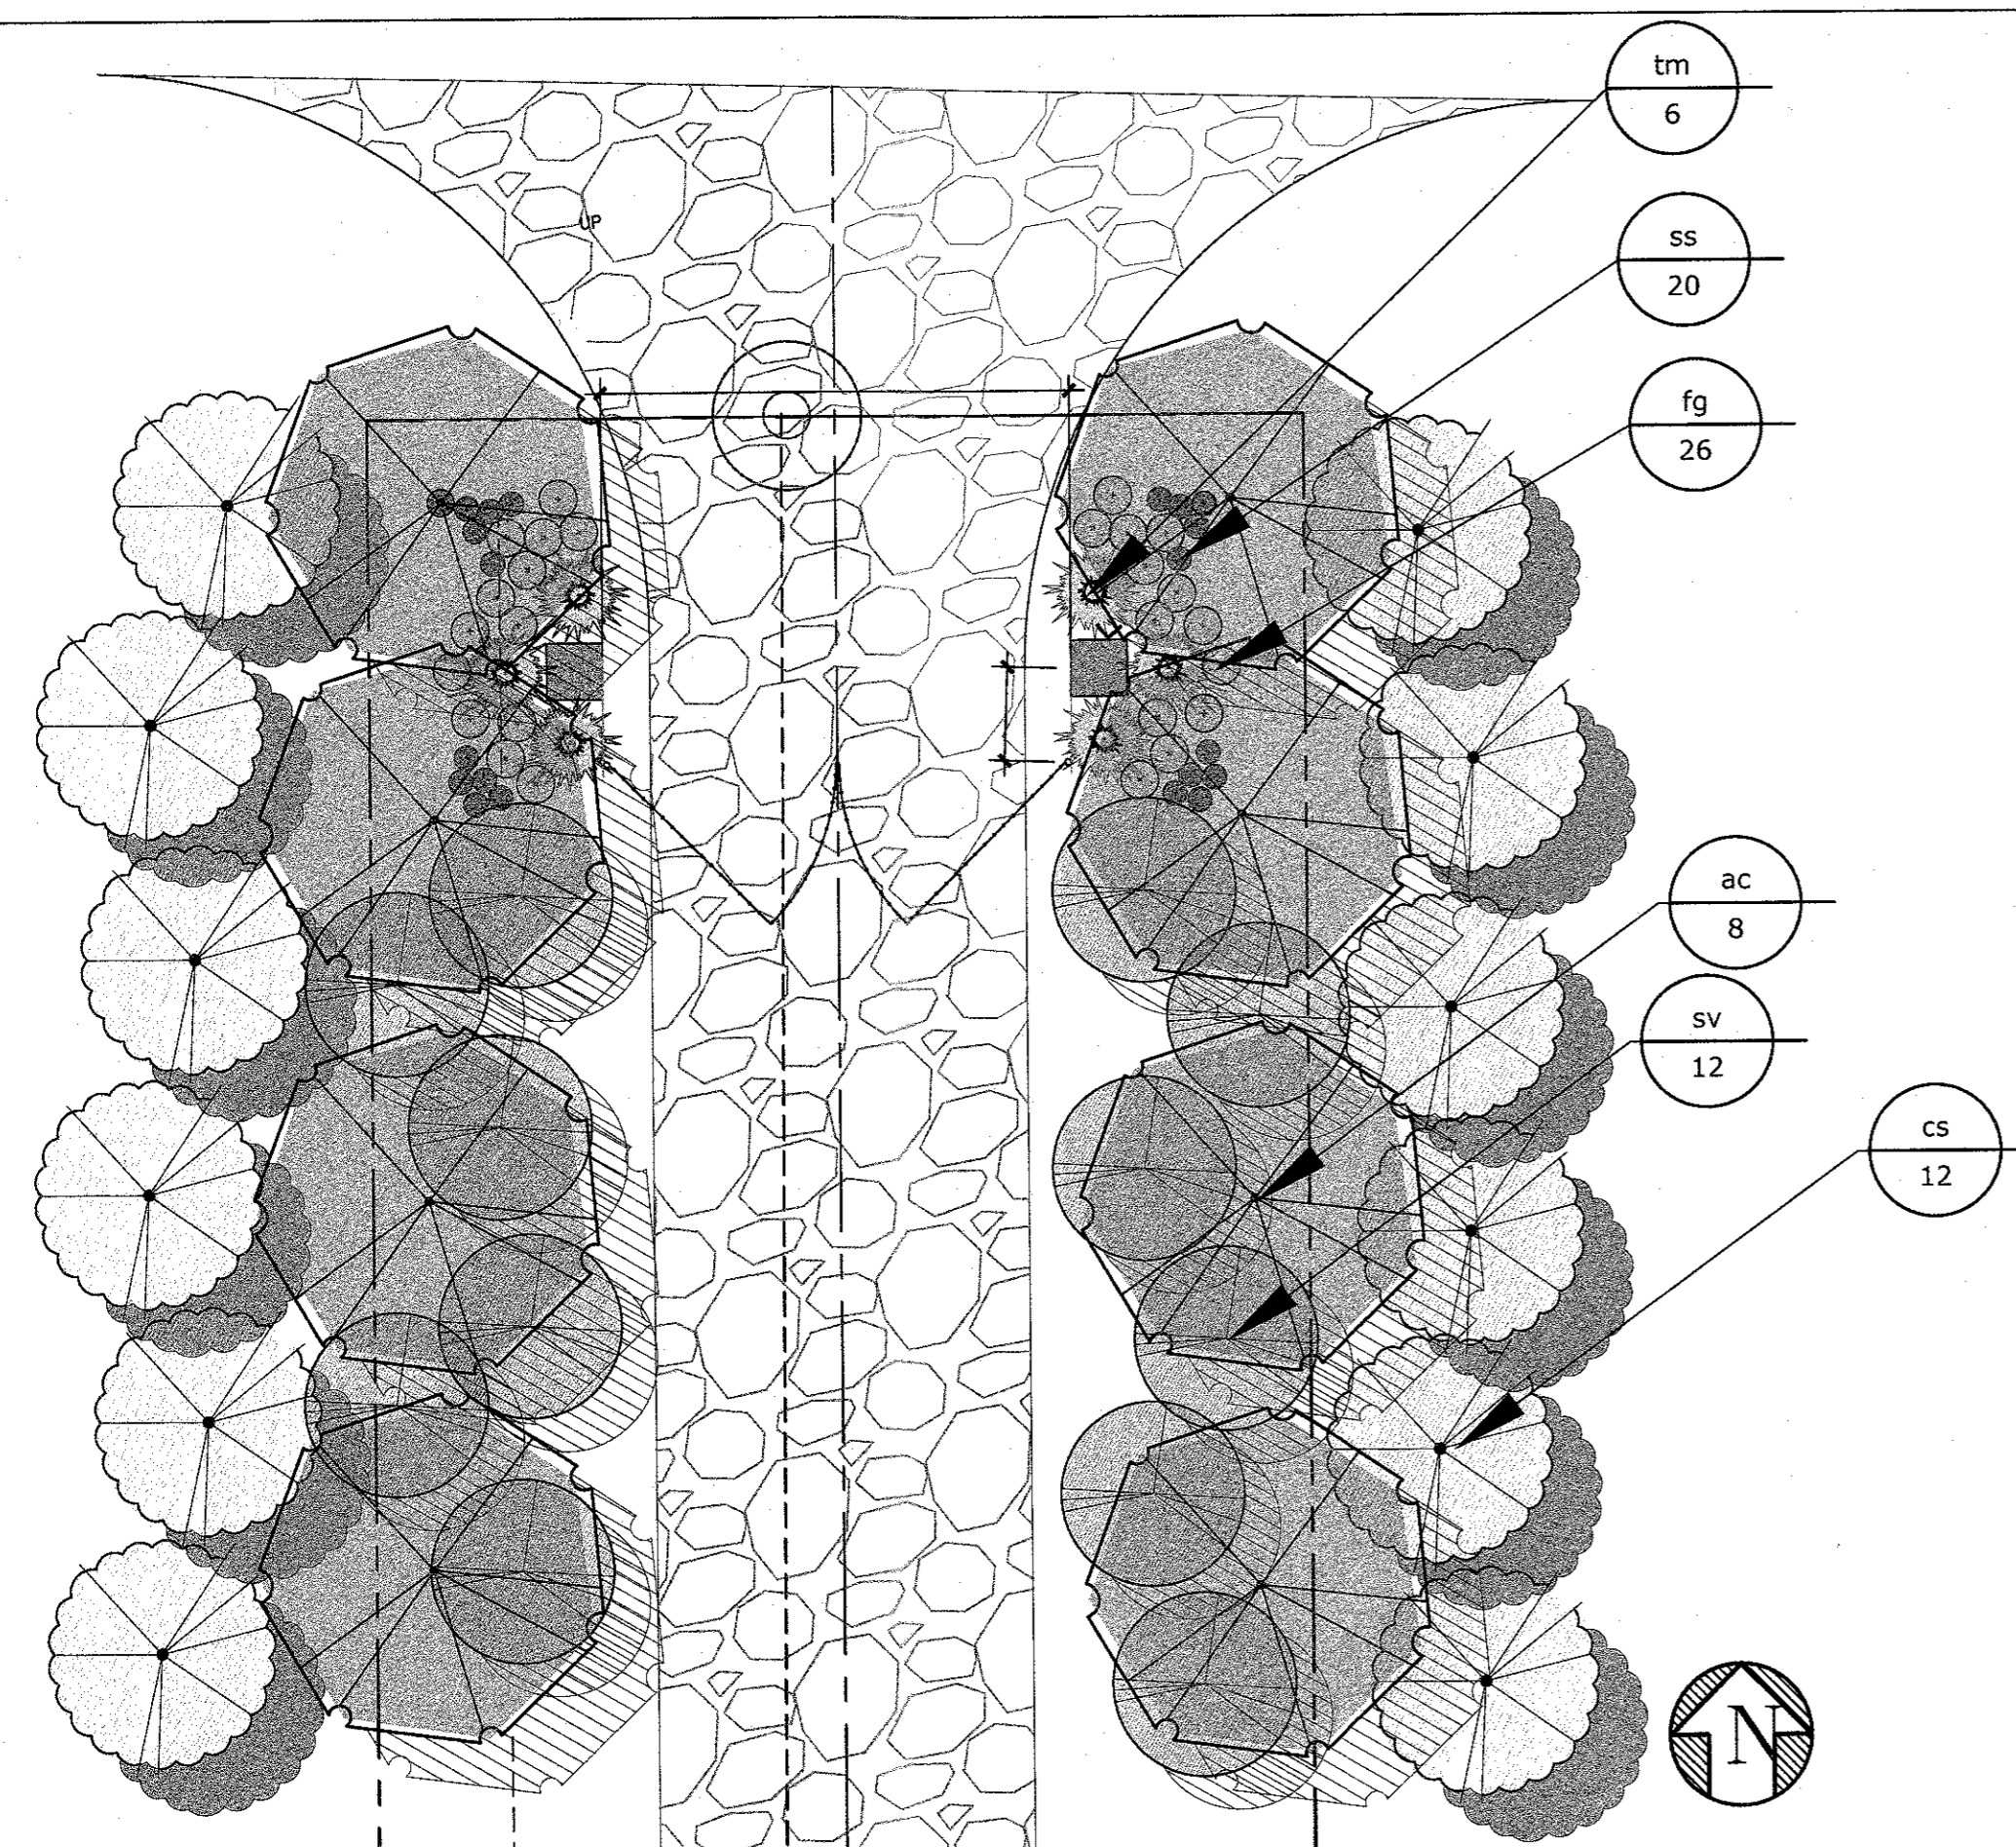

**NOTES:**



- GATES ARE A DELEGATED DESIGN ITEM. DIMENSIONS ARE PROVIDED FOR BIDDING INFORMATION ONLY. ALL GATE DIMENSIONS SHALL BE FIELD VERIFIED BY THE CONTRACTOR PRIOR TO FABRICATION. CONTRACTOR SHALL SUBMIT SHOP DRAWINGS FOR APPROVAL BY OWNER'S REPRESENTATIVE PRIOR TO FABRICATION.
- THICKNESS OF ALL GATE POSTS AND RAILS ARE MINIMUM REQUIREMENTS.
- MINIMUM CLEAR OPENING FOR GATE IS 24'.
- INSTALL BARRIER FATE AND POSTS AS PER MANUFACTURERS SPECIFICATIONS.
- PERIMETER GATES SECURED FOR RESTRICTED ACCESS MUST BE EQUIPPED WITH AN EMERGENCY SERVICES RAPID ENTRY SYSTEM. PROVIDE KNOX EXTERIOR PADLOCK MODEL 3770. THE KNOX PADLOCK SHALL BE DAISY CHAINED WITH THE OWNER PROVIDED PADLOCKS.

**1 MEADOW HILL ROAD ENTRANCE PLANTING**

SCALE: 1" = 10'  
CROSS REFERENCE: NONE

**2 MEADOW HILL ROAD ENTRANCE GATE ELEVATION**

SCALE: 1" = 30'  
CROSS REFERENCE: NONE

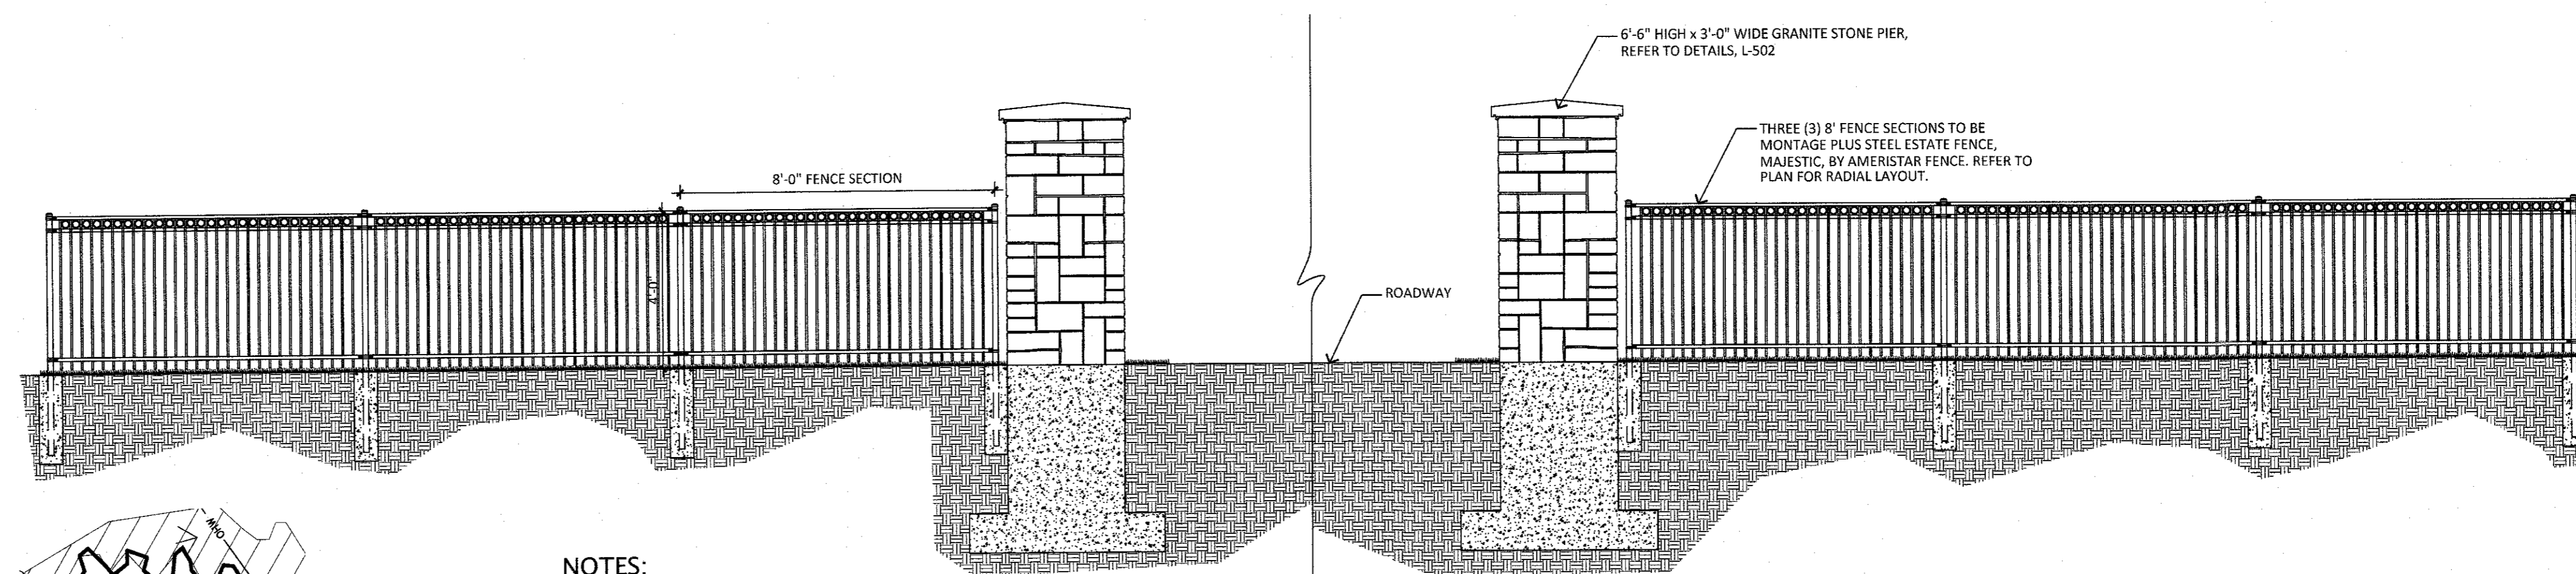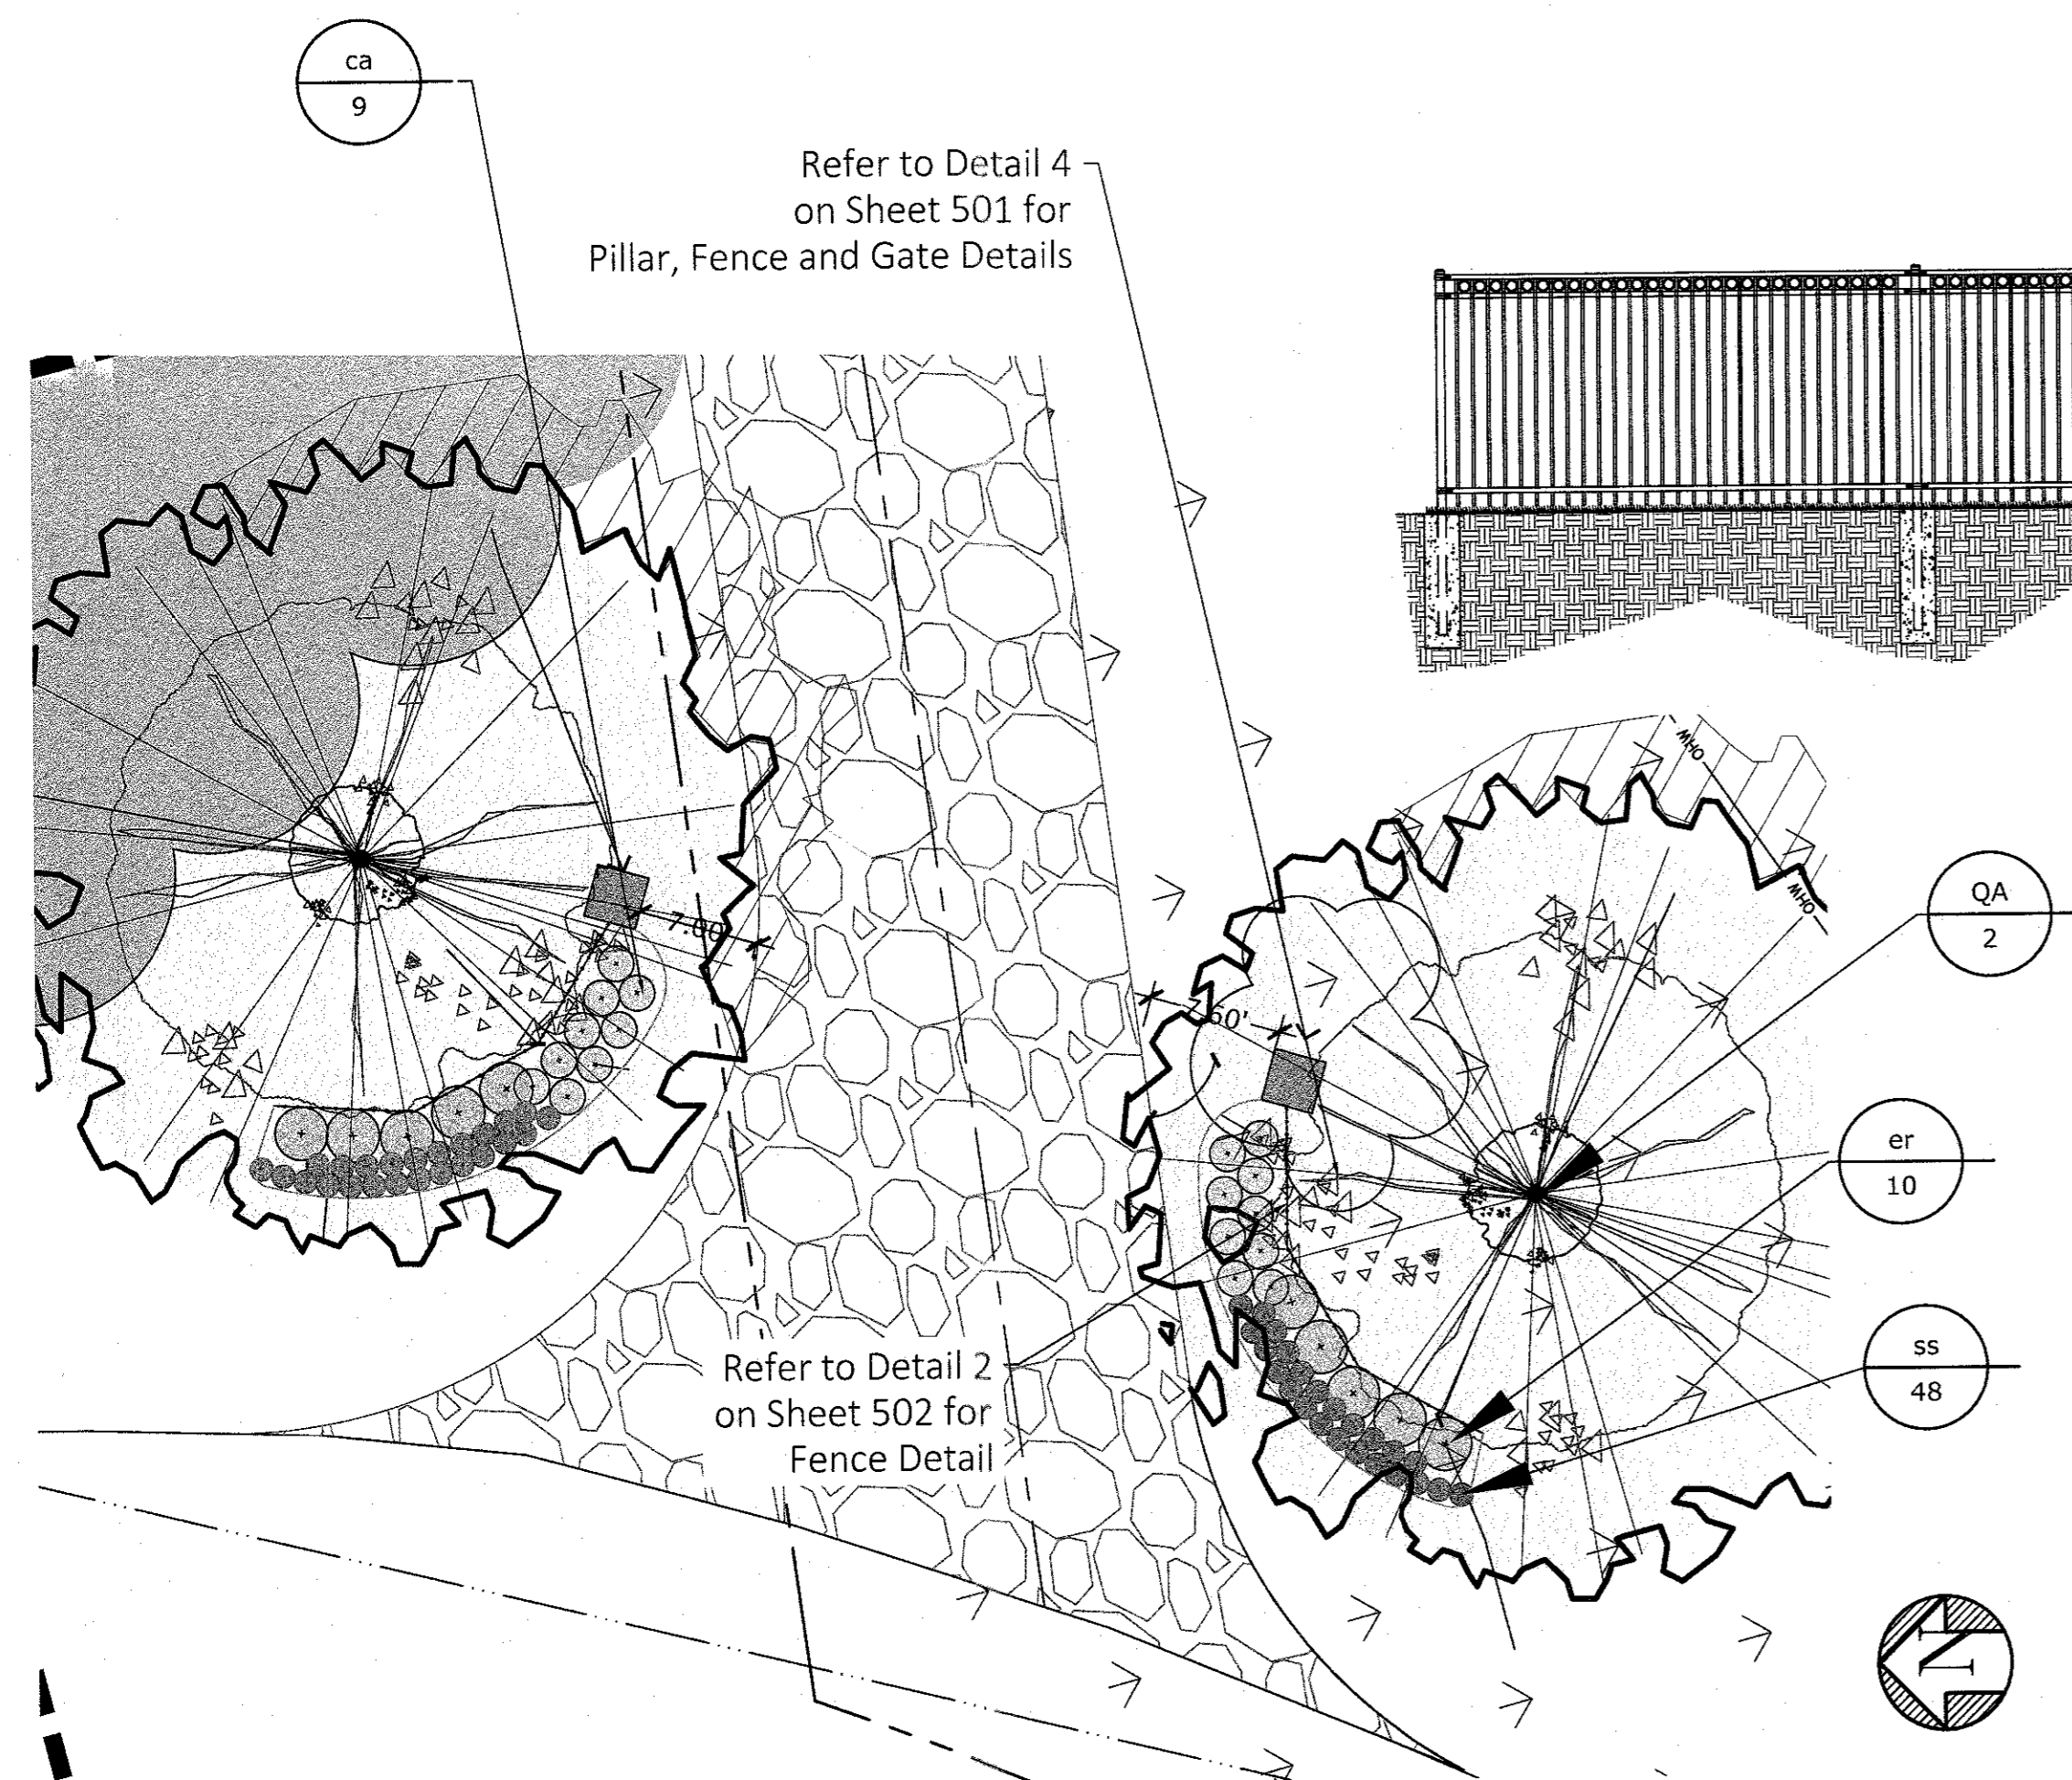

**NOTES:**

- FENCES ARE A DELEGATED DESIGN ITEM. DIMENSIONS ARE PROVIDED FOR BIDDING INFORMATION ONLY. ALL FENCE DIMENSIONS SHALL BE FIELD VERIFIED BY THE CONTRACTOR PRIOR TO FABRICATION. CONTRACTOR SHALL SUBMIT SHOP DRAWINGS FOR APPROVAL BY OWNER OR OWNER'S REPRESENTATIVE PRIOR TO FABRICATION.
- THICKNESS OF ALL FENCE POSTS AND RAILS ARE MINIMUM REQUIREMENTS.
- INSTALL FENCE AND POSTS AS PER MANUFACTURERS SPECIFICATIONS.

**4 LAKESIDE ROAD ENTRANCE GATE ELEVATION**

SCALE: 1" = 30'  
CROSS REFERENCE: NONE

**3 LAKESIDE ROAD ENTRANCE PLANTING**

SCALE: 1" = 10'  
CROSS REFERENCE: NONE


REV#	DATE	DESCRIPTION
REV#2		
REV#1		
CD		
DD		
SD		
MARK		

PROJECT NO: 33-23  
DRAWING ID:


DRAWN BY: RG CHK'D BY: EM  
SCALE:

SHEET TITLE




**ENTRANCE  
FEATURE  
DETAILS**

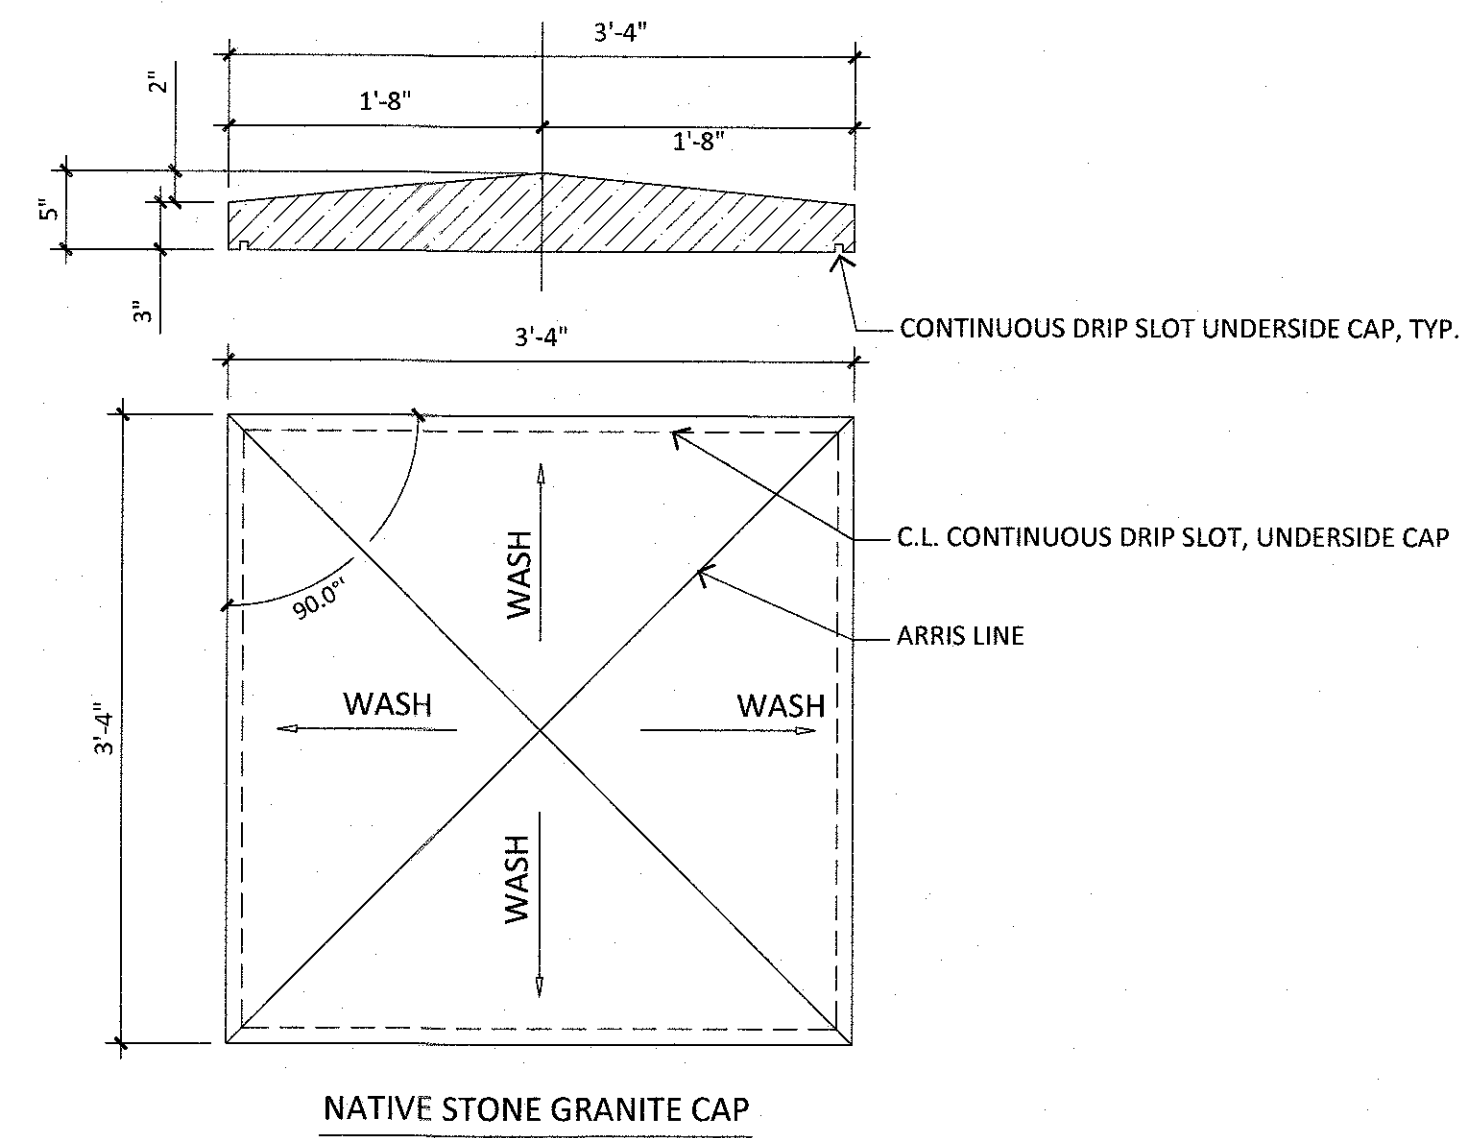

- NOTES:**
- FENCES ARE A DELEGATED DESIGN ITEM. DIMENSIONS ARE PROVIDED FOR BIDDING INFORMATION ONLY. ALL GATE DIMENSIONS SHALL BE FIELD VERIFIED BY THE CONTRACTOR PRIOR TO FABRICATION. CONTRACTOR SHALL SUBMIT SHOP DRAWINGS FOR APPROVAL BY OWNER'S REPRESENTATIVE PRIOR TO FABRICATION. BASIS OF DESIGN SHALL BE MONTAGE PLUS STEEL ESTATE FENCE, MAJESTIC, BY AMERISTAR FENCE.
  - THICKNESS OF ALL GATE POSTS, RAILS, AND PICKETS ARE MINIMUM REQUIREMENTS.
  - ALL METAL FRAMES, PICKETS, POSTS, RAILS, AND HARDWARE SHALL CONSIST OF GALVANIZED STEEL WITH GAUGE SIZES AS INDICATED PER THE MANUFACTURER'S RECOMMENDATION.
  - ALL STEEL MEMBERS AND HARDWARE SHALL BE HOT-DIPPED GALVANIZED WITH A BLACK POWDER COATED FINISH.
  - POST SIZE DEPENDS ON FENCE HEIGHT, WEIGHT AND WIND LOADS. SEE MONTAGE PLUS SPECIFICATIONS FOR POST SIZING CHART.
  - INCLUDE DOUBLE RING ADORNMENT. THIRD RAIL REQUIRED FOR DOUBLE RINGS.
  - FENCE SHALL BE POWDER COATED BLACK (IN SHOP). ONLY MINOR TOUCH-UP PAINTING SHALL BE PERMITTED ON SITE.

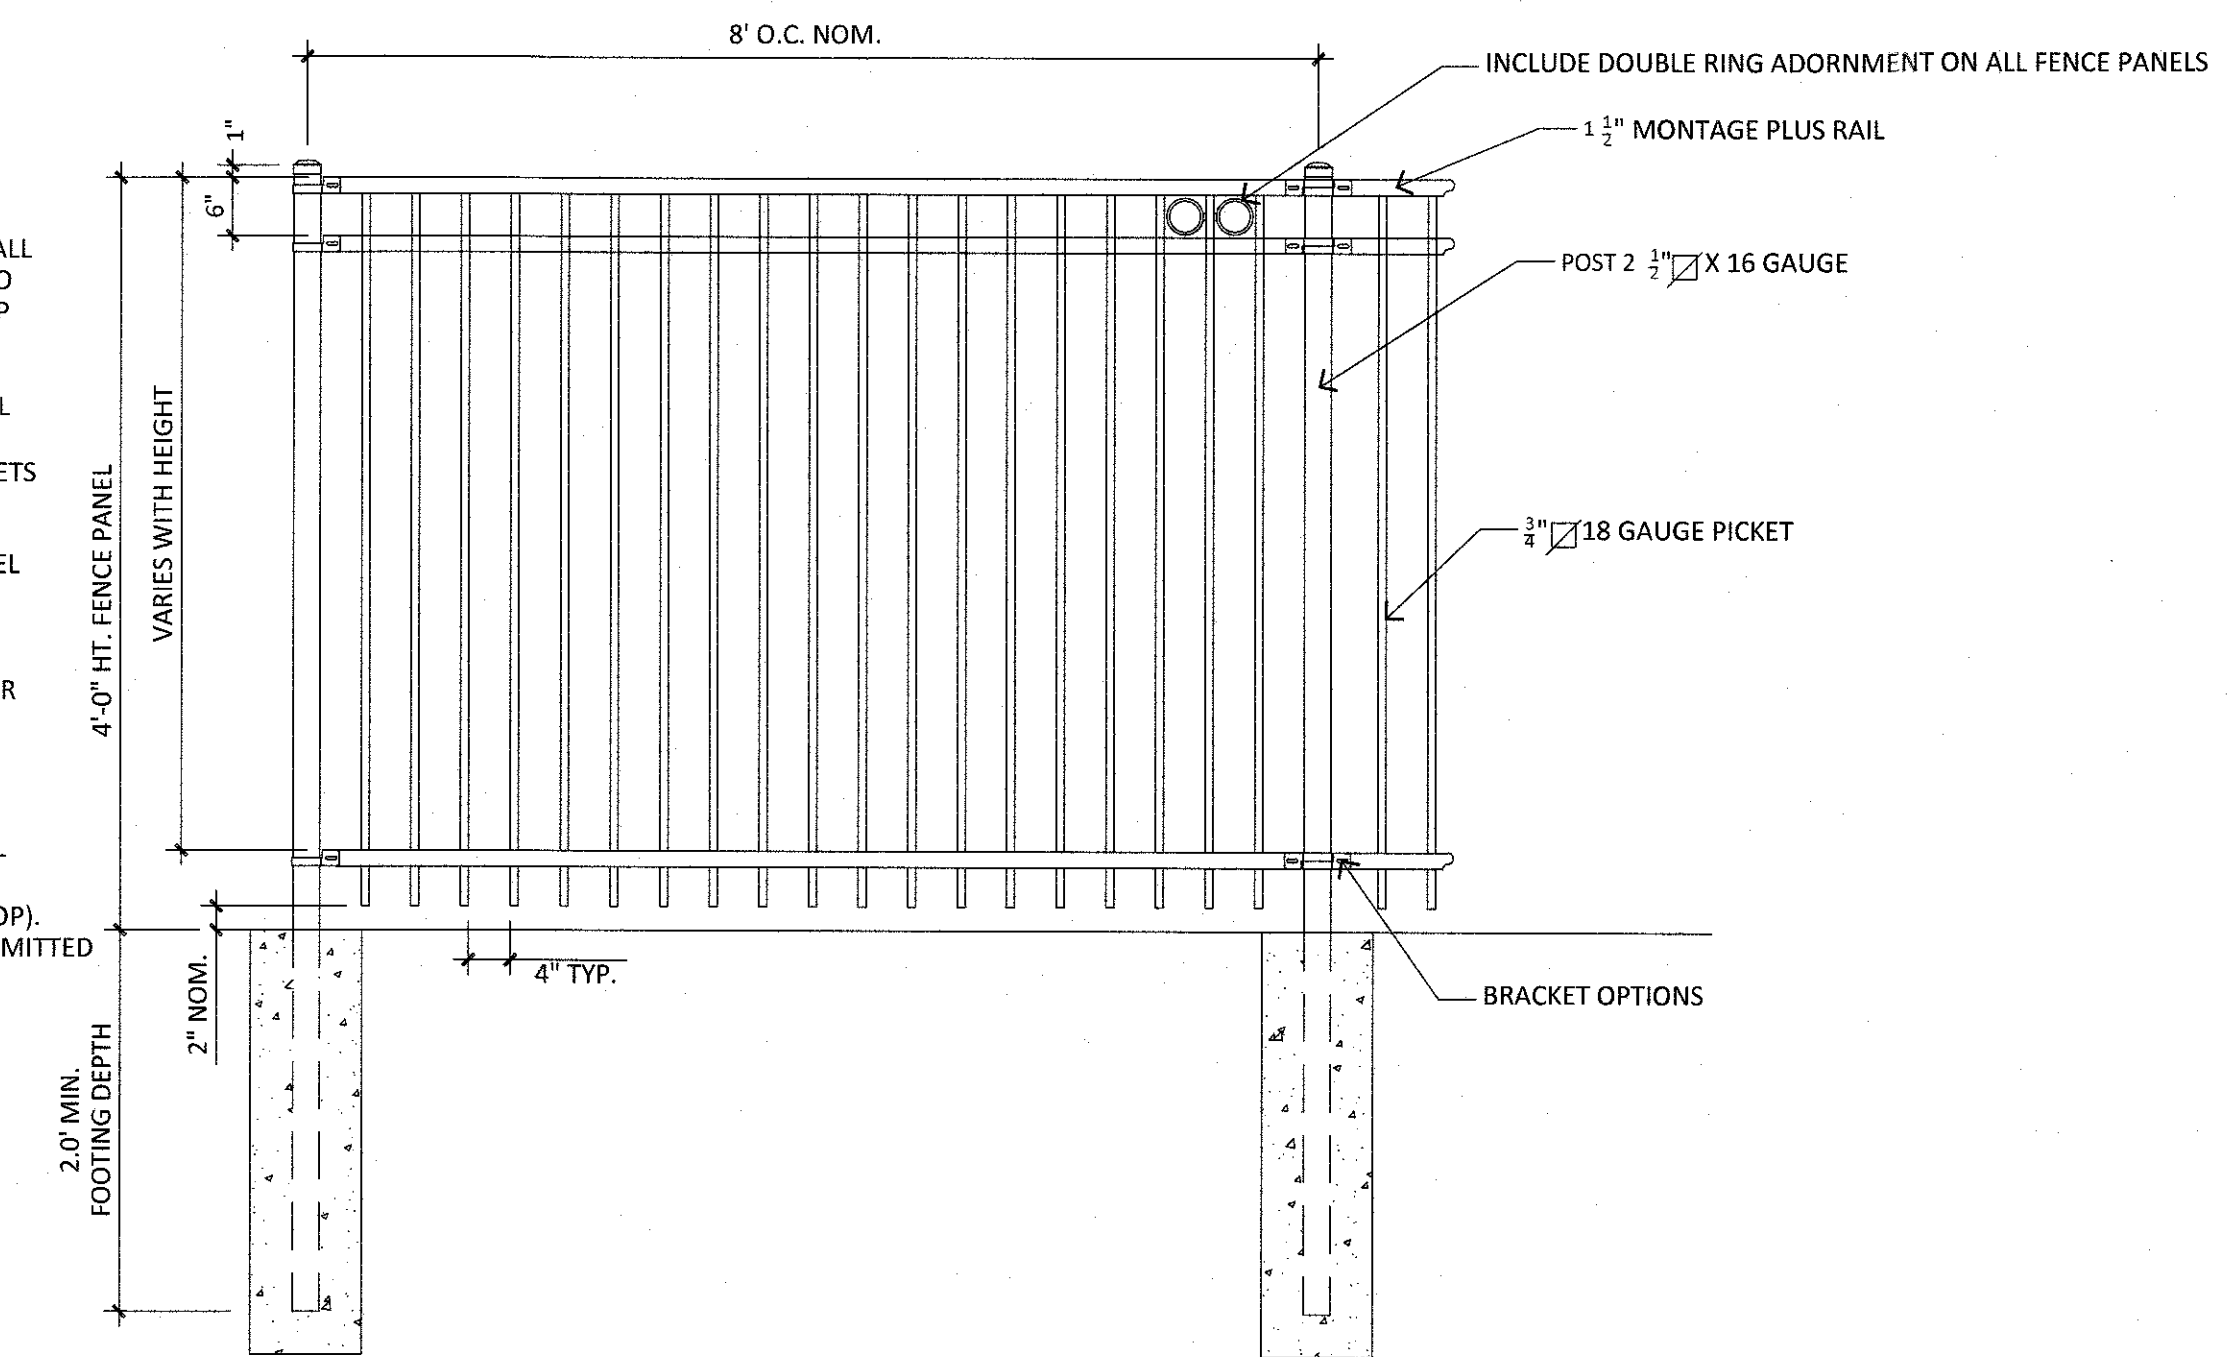

**2 DECORATIVE METAL FENCE PANEL**  
SCALE: NTS  
CROSS REFERENCE: NONE

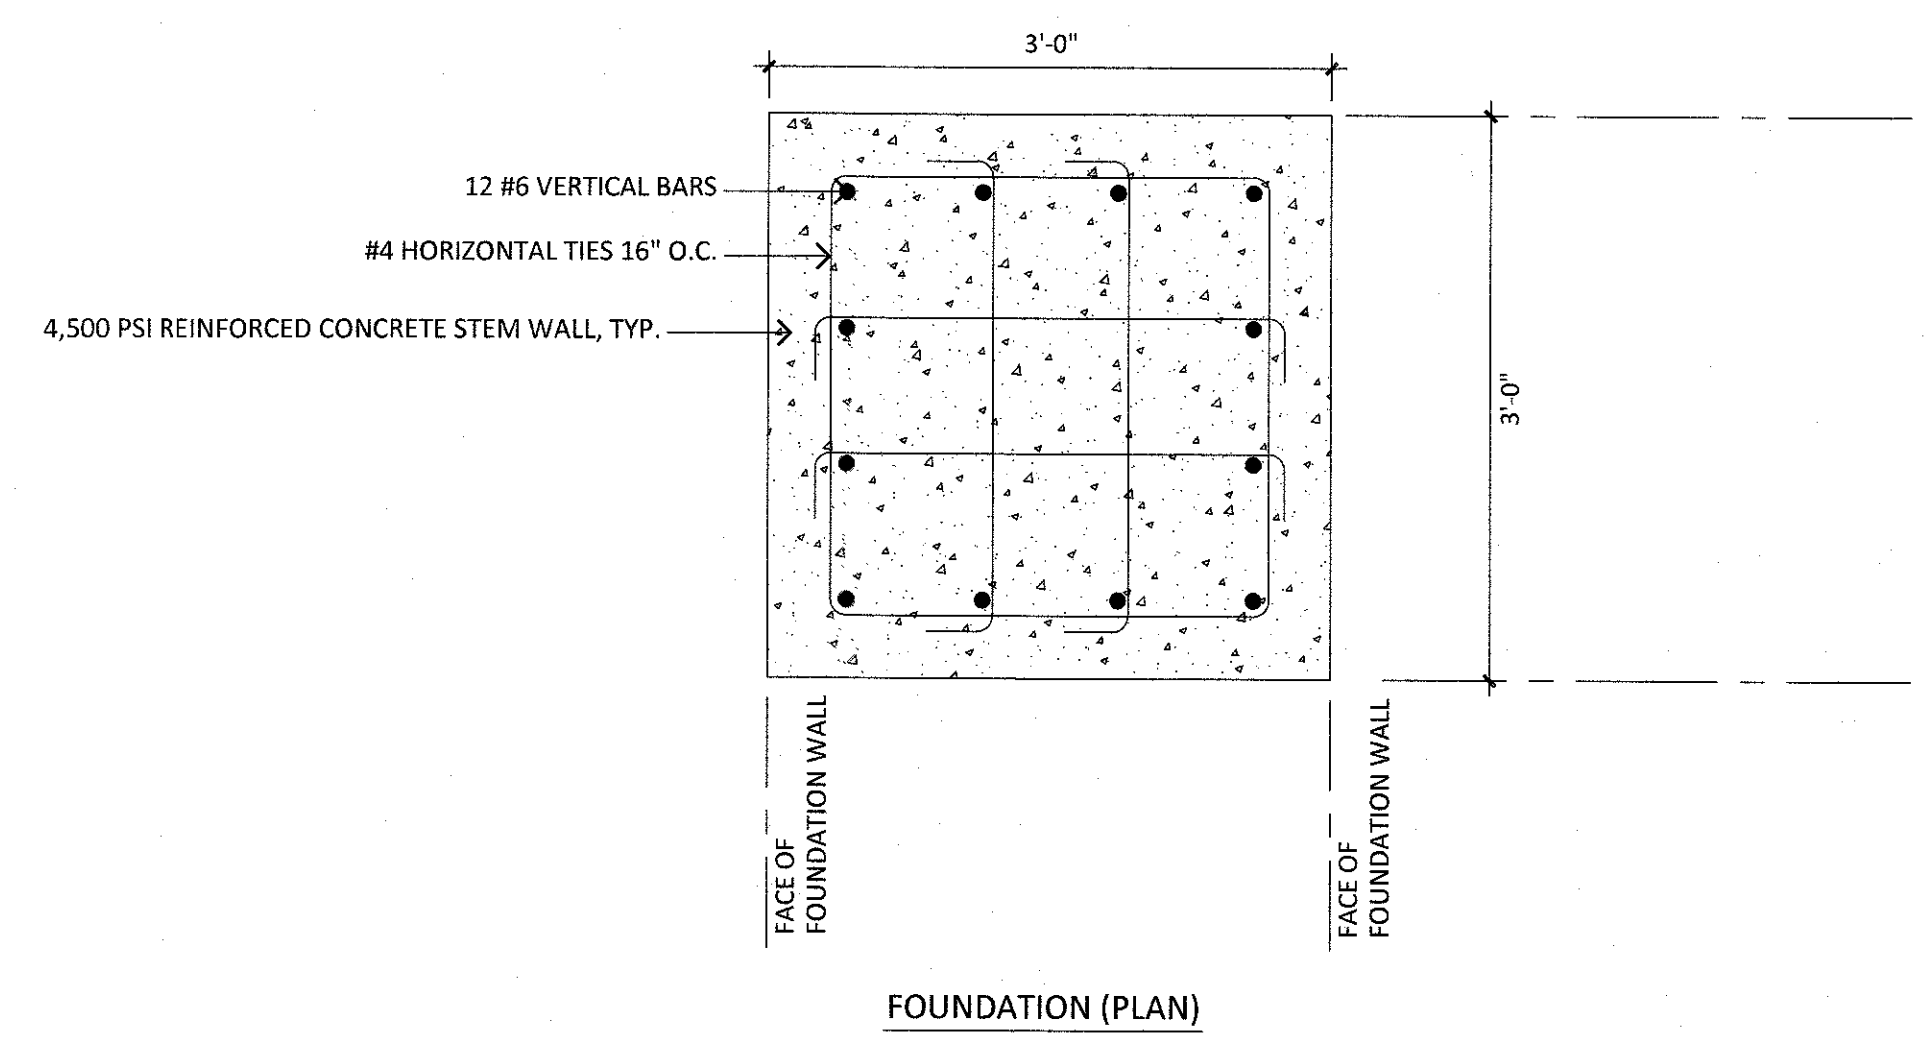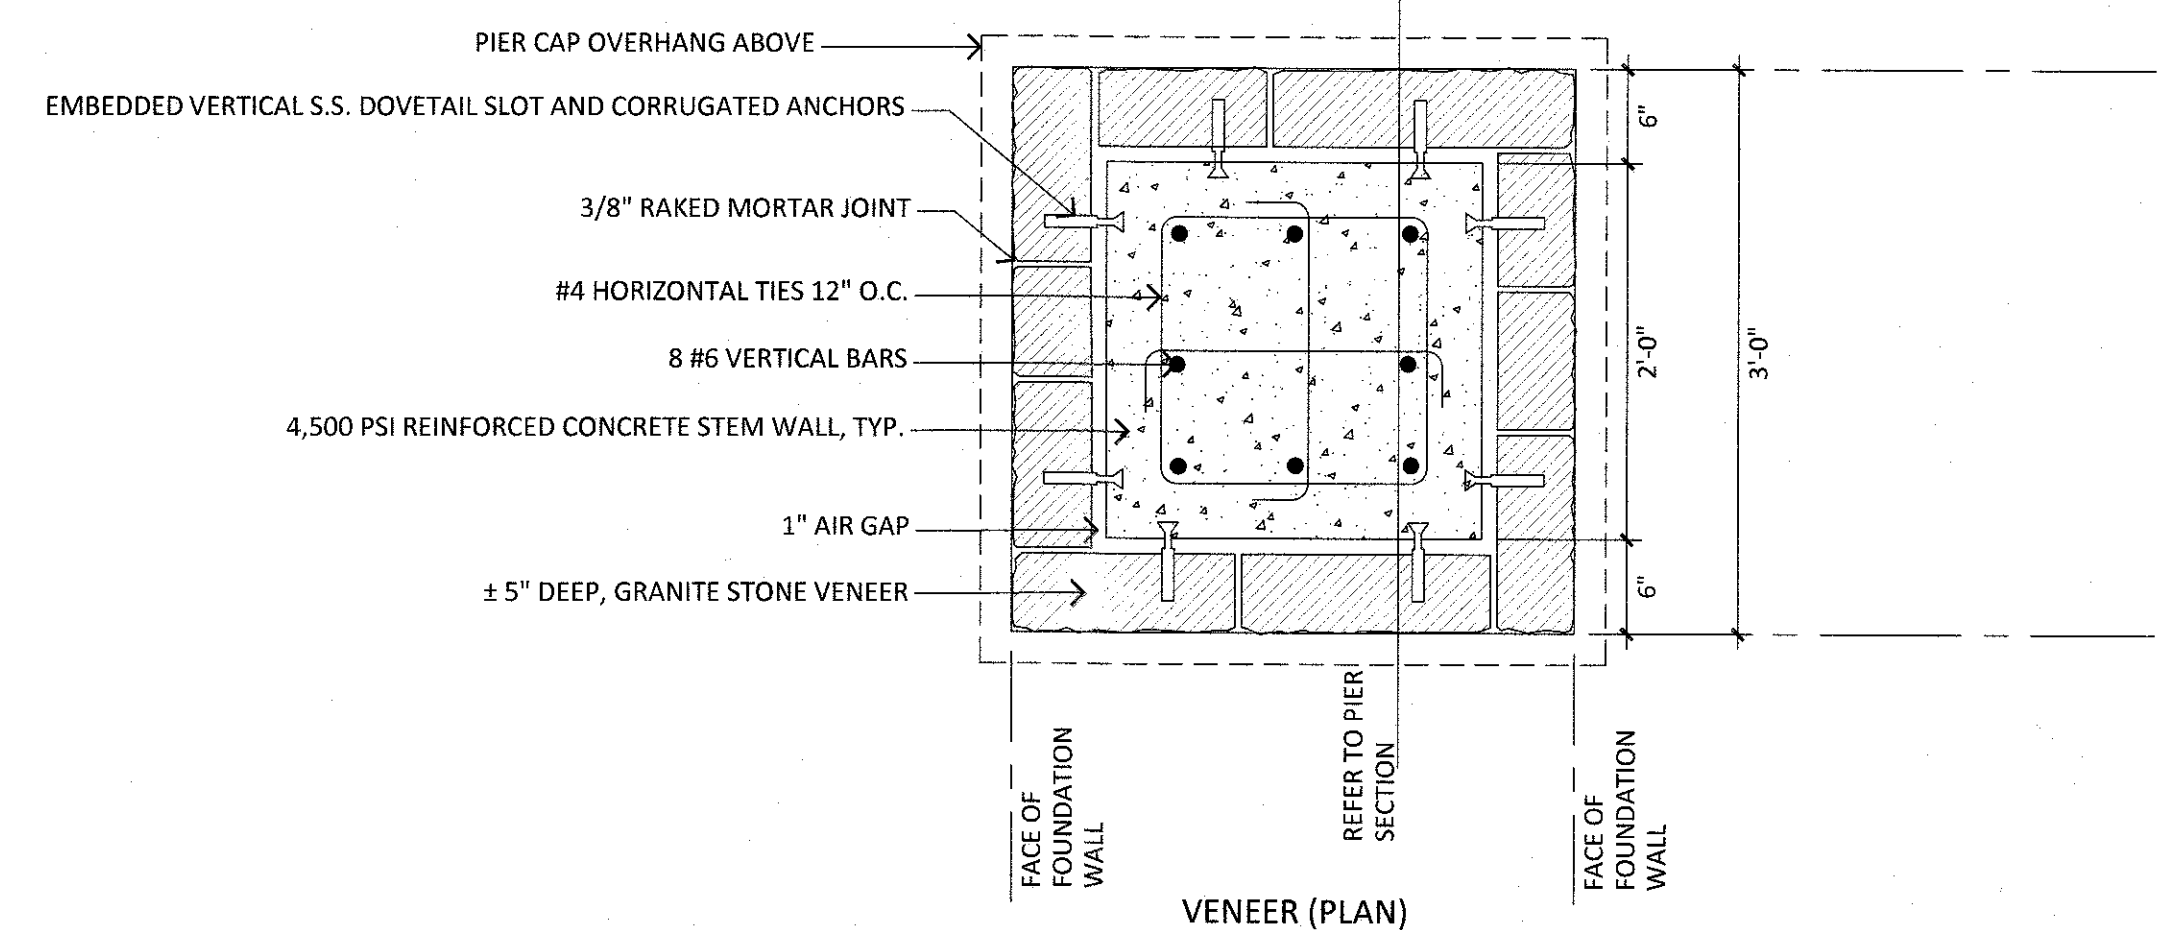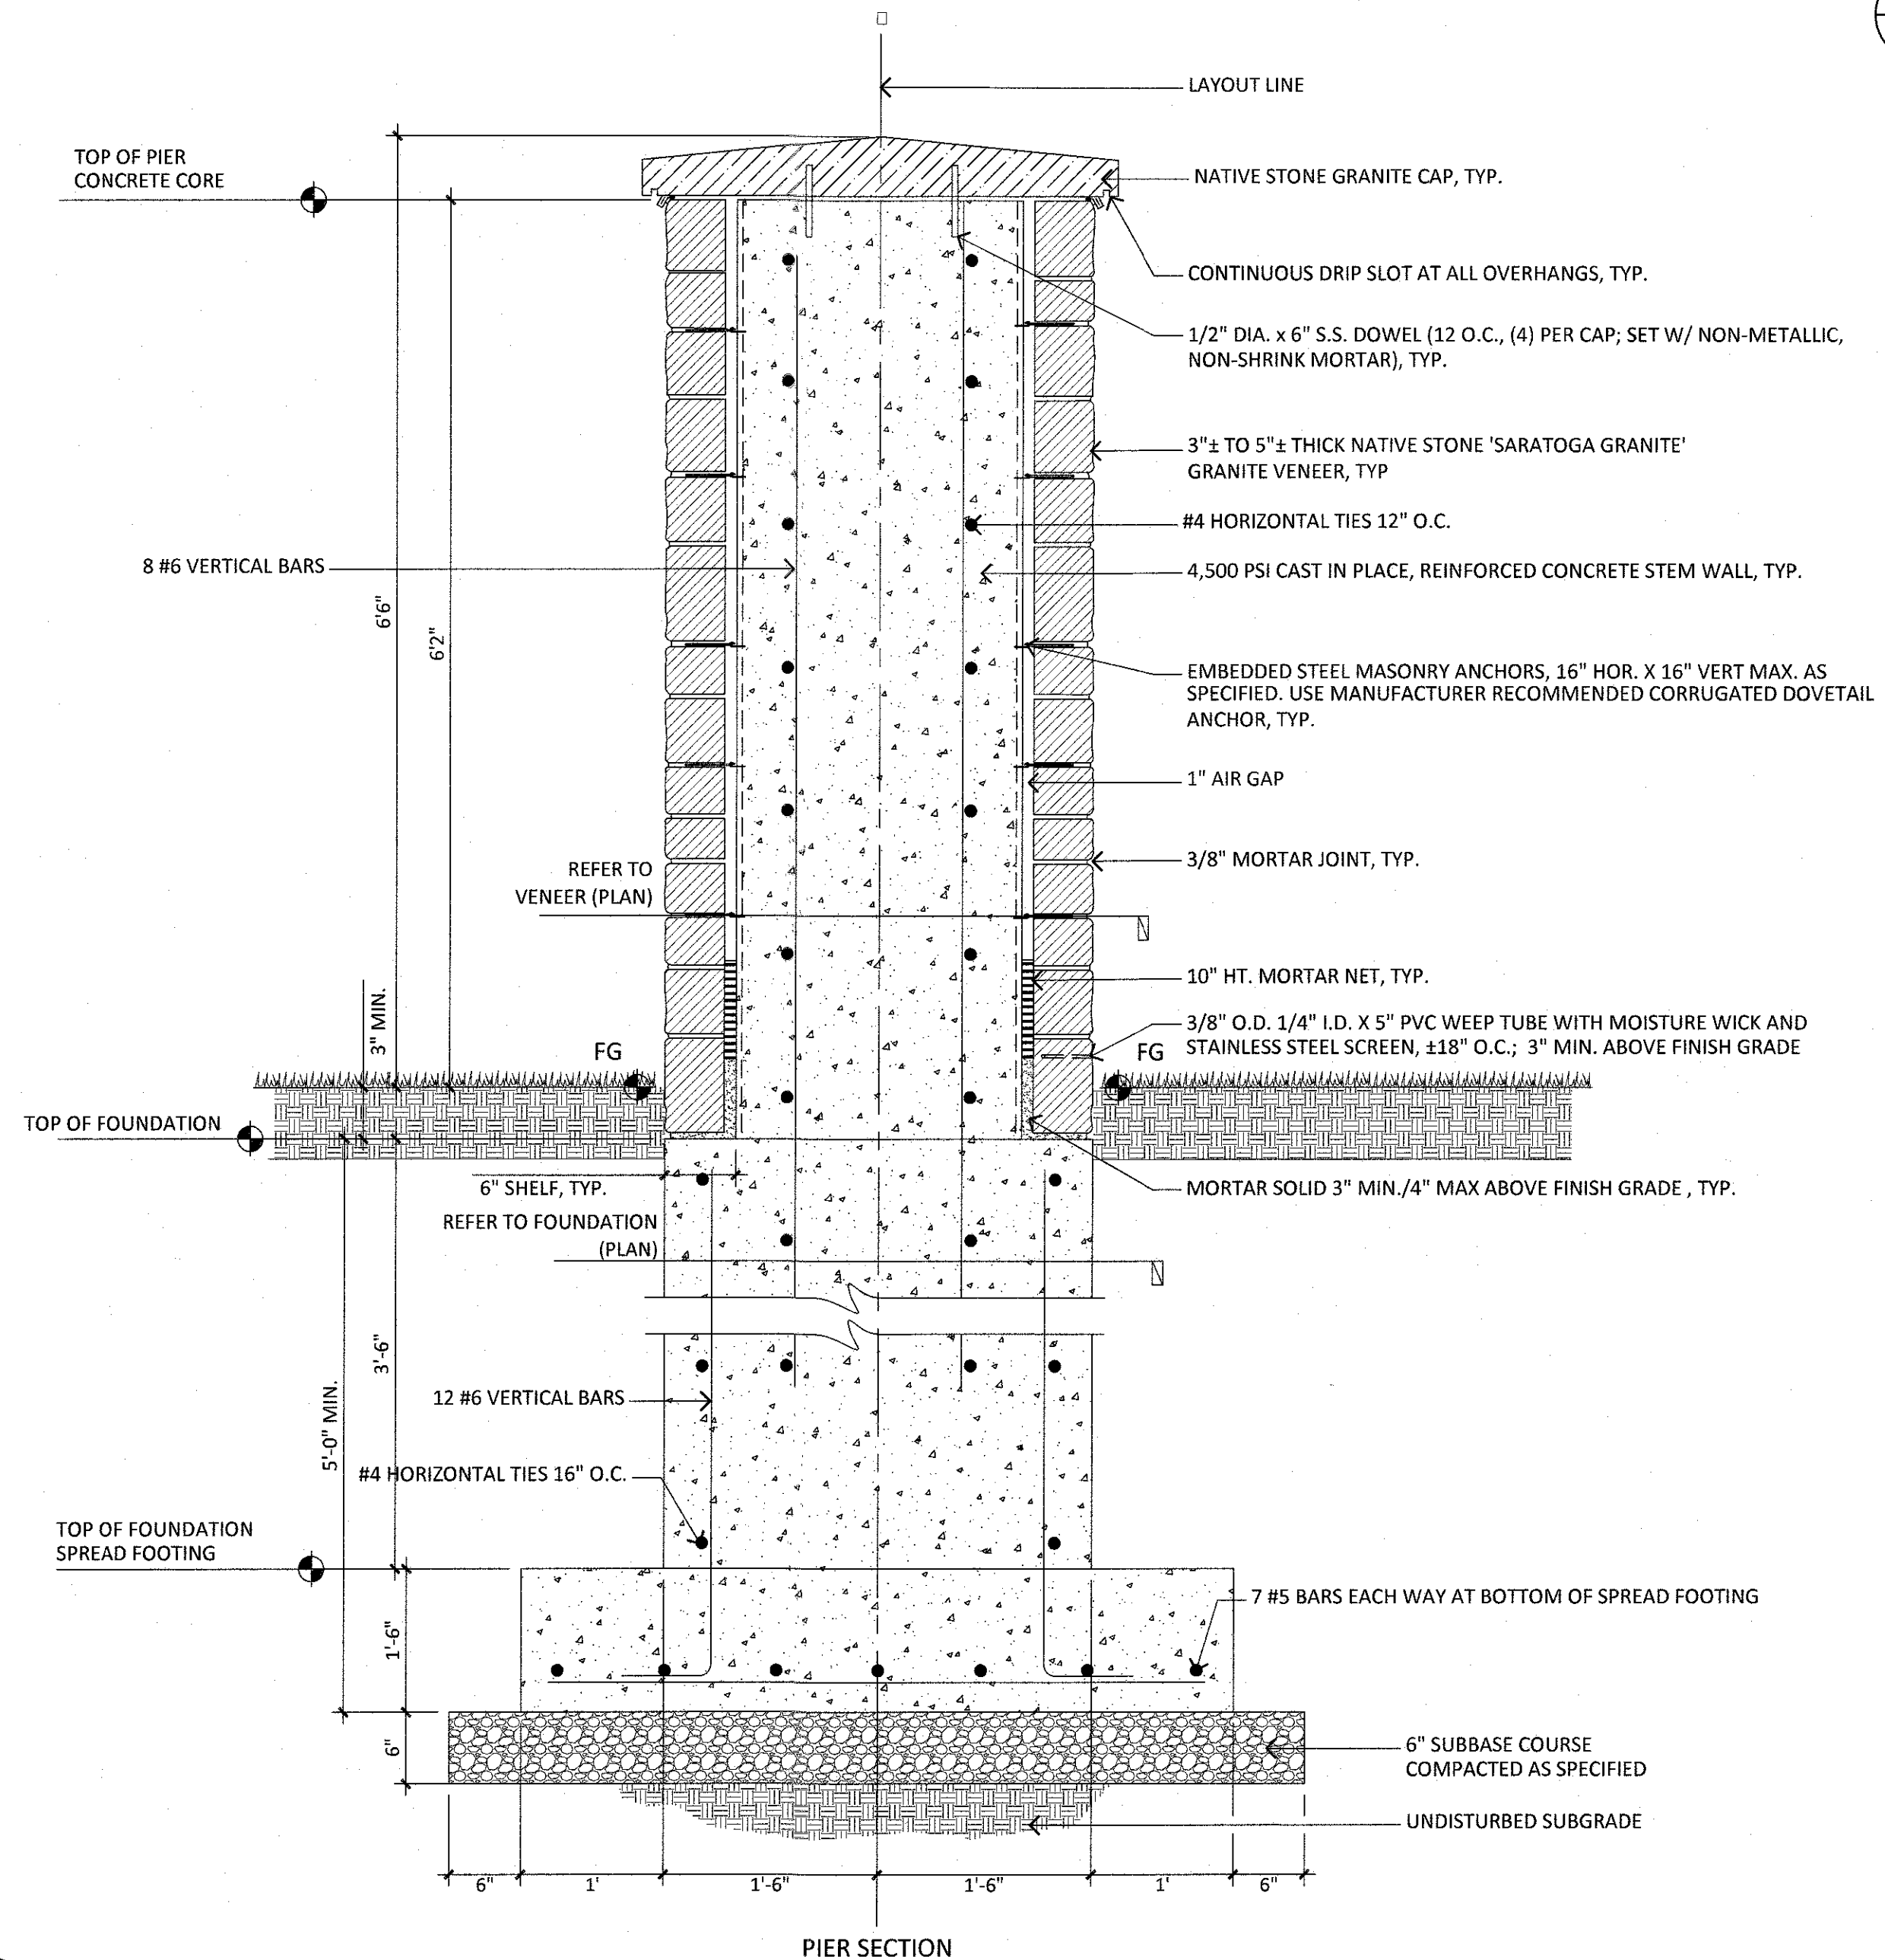

**PROTECTION OF STONE MASONRY NOTE:**  
DURING CONSTRUCTION, COVER TOPS OF WALLS, PROJECTIONS, AND SILLS WITH WATERPROOF SHEETING AT END OF EACH DAY'S WORK. ANY WORK THAT IS NOT PROTECTED AND BECOMES WETTED FROM INCIDENT MOISTURE SHALL BE REMOVED IN ITS ENTIRETY BEFORE FURTHER WORK CONTINUES.

**1 ENTRANCE PIERS**  
SCALE: NTS  
CROSS REFERENCE: NONE